## Z RIVERVIEW PARK MASTER PLAN

## COVER SHEET

#### PROPERTY DESCRIPTION:

NE QUARTER OF THE SE QUARTER SECTION EASTERLY ONE-HALF OF SW QUARTER SECTION

NO OFFICIAL PLAT RECORDED WITH THE CITY OF CLINTON, CLINTON COUNTY, IOWA.

SUBJECT TO AND TOGETHER WITH ANY AND ALL EASEMENTS AND RESTRICTIONS OF

INTERSTATE POWER AND LIGHT COMPANY: 409, 899.6 SQUARE FEET - 9.41 ACRES CITY OF CLINTON: 472,772 (±) SQUARE FEET - 10.85 (±) ACRES

INTERSTATE POWER AND LIGHT COMPANY

CLINTON, IA 52732

CITY OF CLINTON 251 BALL PARK DRIVE CLINTON, IA 52732

#### OWNER:

CITY OF CLINTON PO BOX 2958

(563) 242-2144 PREPARED FOR:

CLINTON, IA 52733

#### CITY OF CLINTON PO BOX 2958

CLINTON, IA 52733 (563) 242-2144

INFORMATION OBTAINED FROM CLINTON COUNTY ASSESSORS

INTERSTATE POWER AND LIGHT COMPANY: C -COMMERCIAL CITY OF CLINTON: C -COMMERCIAL

FOR AN OFFICIAL ZONING REPORT PLEASE CALL THE CITY OF CLINTON, IA AT 563-244-3423

#### SITE CHARACTERISTICS:

±882,672 SF (100%)(±20.26 ACRES) EXISTING IMPERVIOUS AREA PRIOR TO DEMOLITION ±115,167 SF (13.1%) EXISTING BUILDING AREA

±36,483 SF (4.1%) PROPOSED BUILDING AREA 480 SF (0.01%) 122,035 SF (13.8%) PROPOSED PAVING AREA PROPOSED GREEN SPACE 760,157 SF (86.1%)

TOTAL IMPERVIOUS AREA HAS BEEN INCREASED BY 4,948 S.F. WITH NEW SITE

SCALE: N/A


#### **GENERAL NOTES:**

THIS DOCUMENT PROVIDES DETAILS TO COMPLEMENT THE RIVERVIEW PARK MASTER PLAN DATED DECEMBER 9, 2022. THESE DETAILS ARE FOR PLANNING PURPOSES ONLY AND SHOULD NOT BE USED FOR CONSTRUCTION.

- MASTER PLAN OVERVIEW
- C0.2 LAYOUT PLAN
- C1.0 LUBBER FOUNTAIN DEMOLITION PLAN
- LUBBER FOUNTAIN LAYOUT
- C2.0 TRAIL/SIDEWALK DEMOLITION PLAN

- RESTROOM STORM SHELTER
- C4.1 RESTROOM STORM SHELTER FLOOR PLAN

- **ROAD PLAN**
- TEMPORARY STAGE
- C9.0 DETAILS

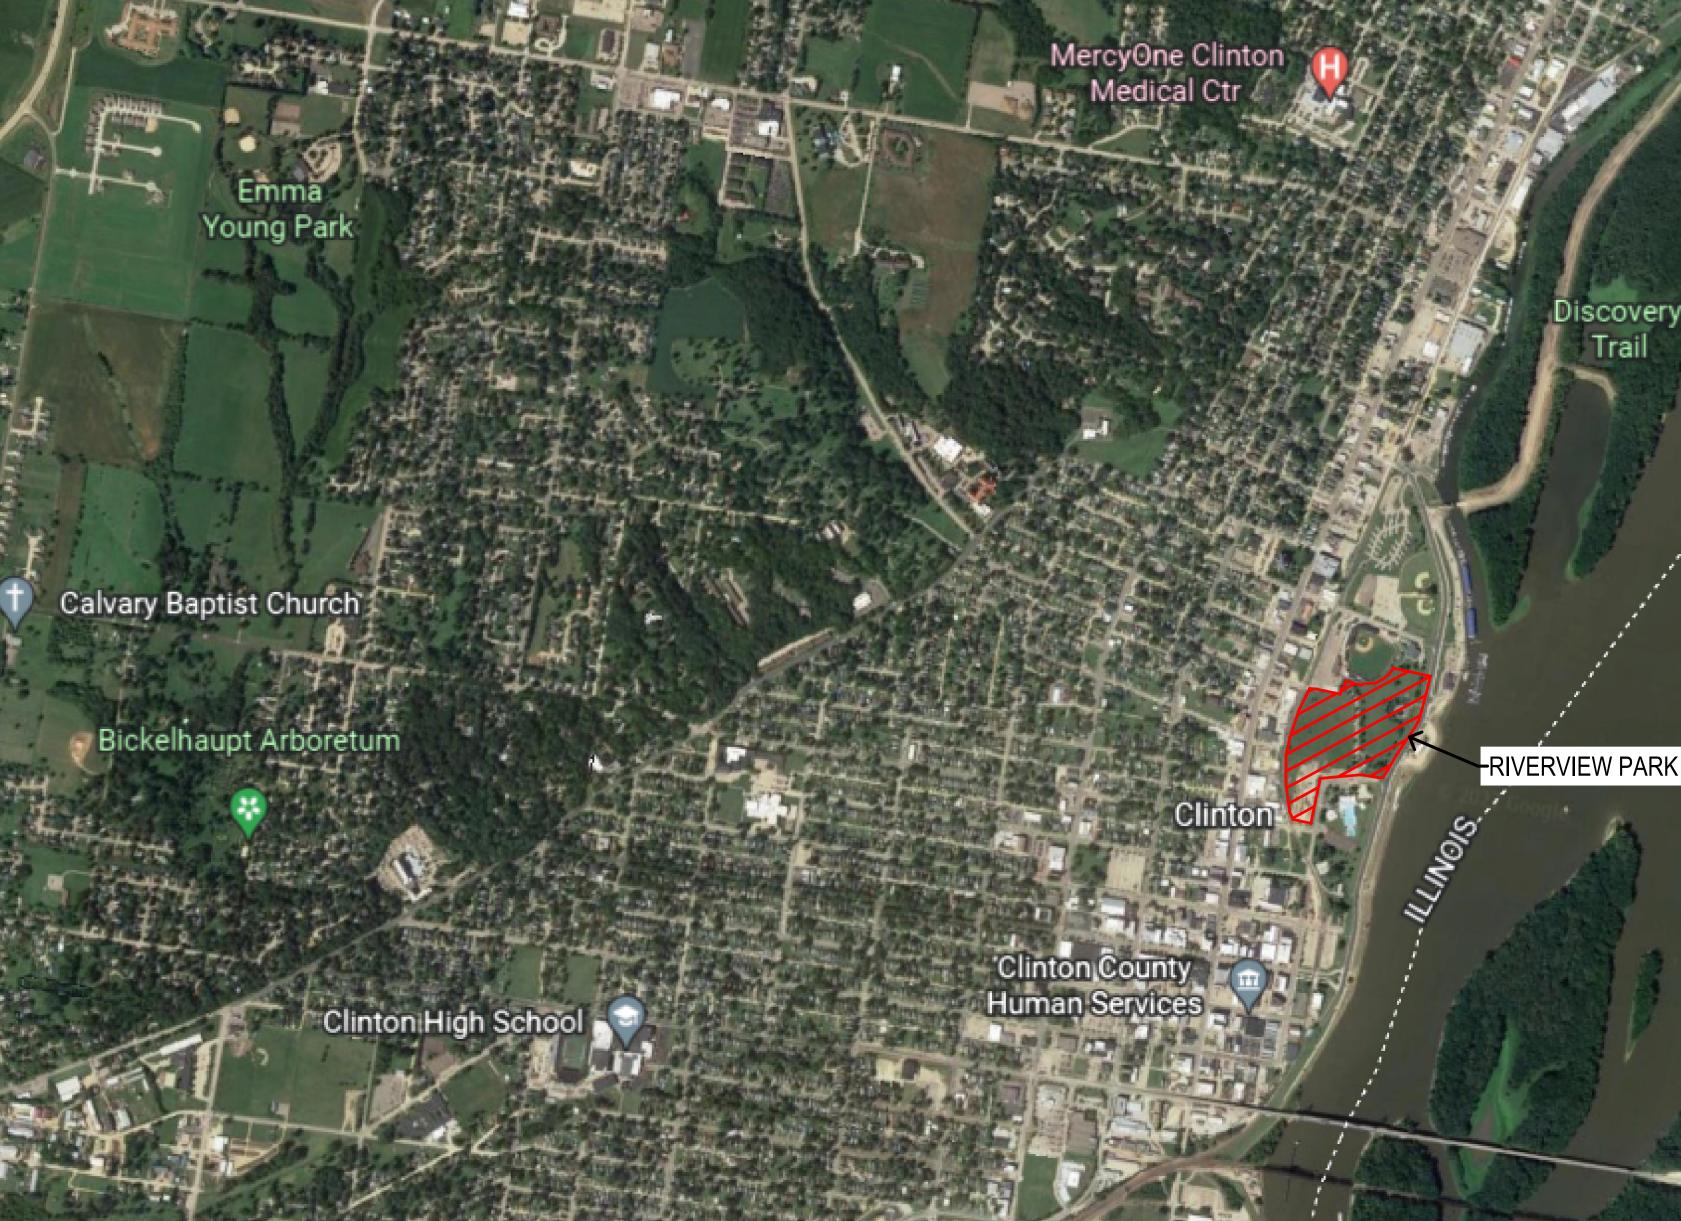

SHEET INDEX:

C0.0 COVER SHEET

TRAIL/SIDEWALK LAYOUT

BANDSHELL LAYOUT

C5.0 DRIVE-IN MOVIE THEATER

PARKING LOT LAYOUT

SHEET NO.

**COVER SHEET** 

SHEET NAME

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#### **UTILITY MAPS PROVIDED BY:** 1. ELECTRIC (MIDAMERICAN) 2. STORM AND SANITARY (CLINTON SEWER)


- 3. FIBER OPTIC (MEDIACOM) 4. FIBER OPTIC (AUREON) 5. FIBER OPTIC (CENTURY LINK)
- 6. FIBER OPTIC (UPN) 7. CABLE (MEDIACOM)
- 8. GAS (MIDAMERICAN GAS) 9. WATER (CITY OF CLINTON)
- 10. TELEPHONE (VERIZON) 11. TELEPHONE (ADB)

1-800-292-8989


www.iowaonecall.com

THE LOCATION OF THE UTILITIES INDICATED ON THE PLANS HAVE BEEN TAKEN FROM EXISTING PUBLIC RECORDS, AND PLANS PROVIDED BY OTHERS. ALL UNDERGROUND UTILITY LOCATIONS ARE APPROXIMATE LOCATIONS ONLY. CMEK ENGINEERING DOES NOT GUARANTEE THE UNDERGROUND LOCATION OF ANY UTILITIES SHOWN. IT SHALL BE THE DUTY OF THE CONTRACTOR TO DETERMINE THE LOCATION AND DEPTH OF ANY UNDERGROUND UTILITIES SHOWN AND IF ANY ADDITIONAL UTILITIES, OTHER THAN THOSE SHOWN ON THE PLANS, MAY BE PRESENT. A REQUEST WAS MADE TO IOWA ONE CALL FOR UTILITY PROVIDERS TO VERIFY, LOCATE, AND MARK THEIR UTILITIES IN THE FIELD.



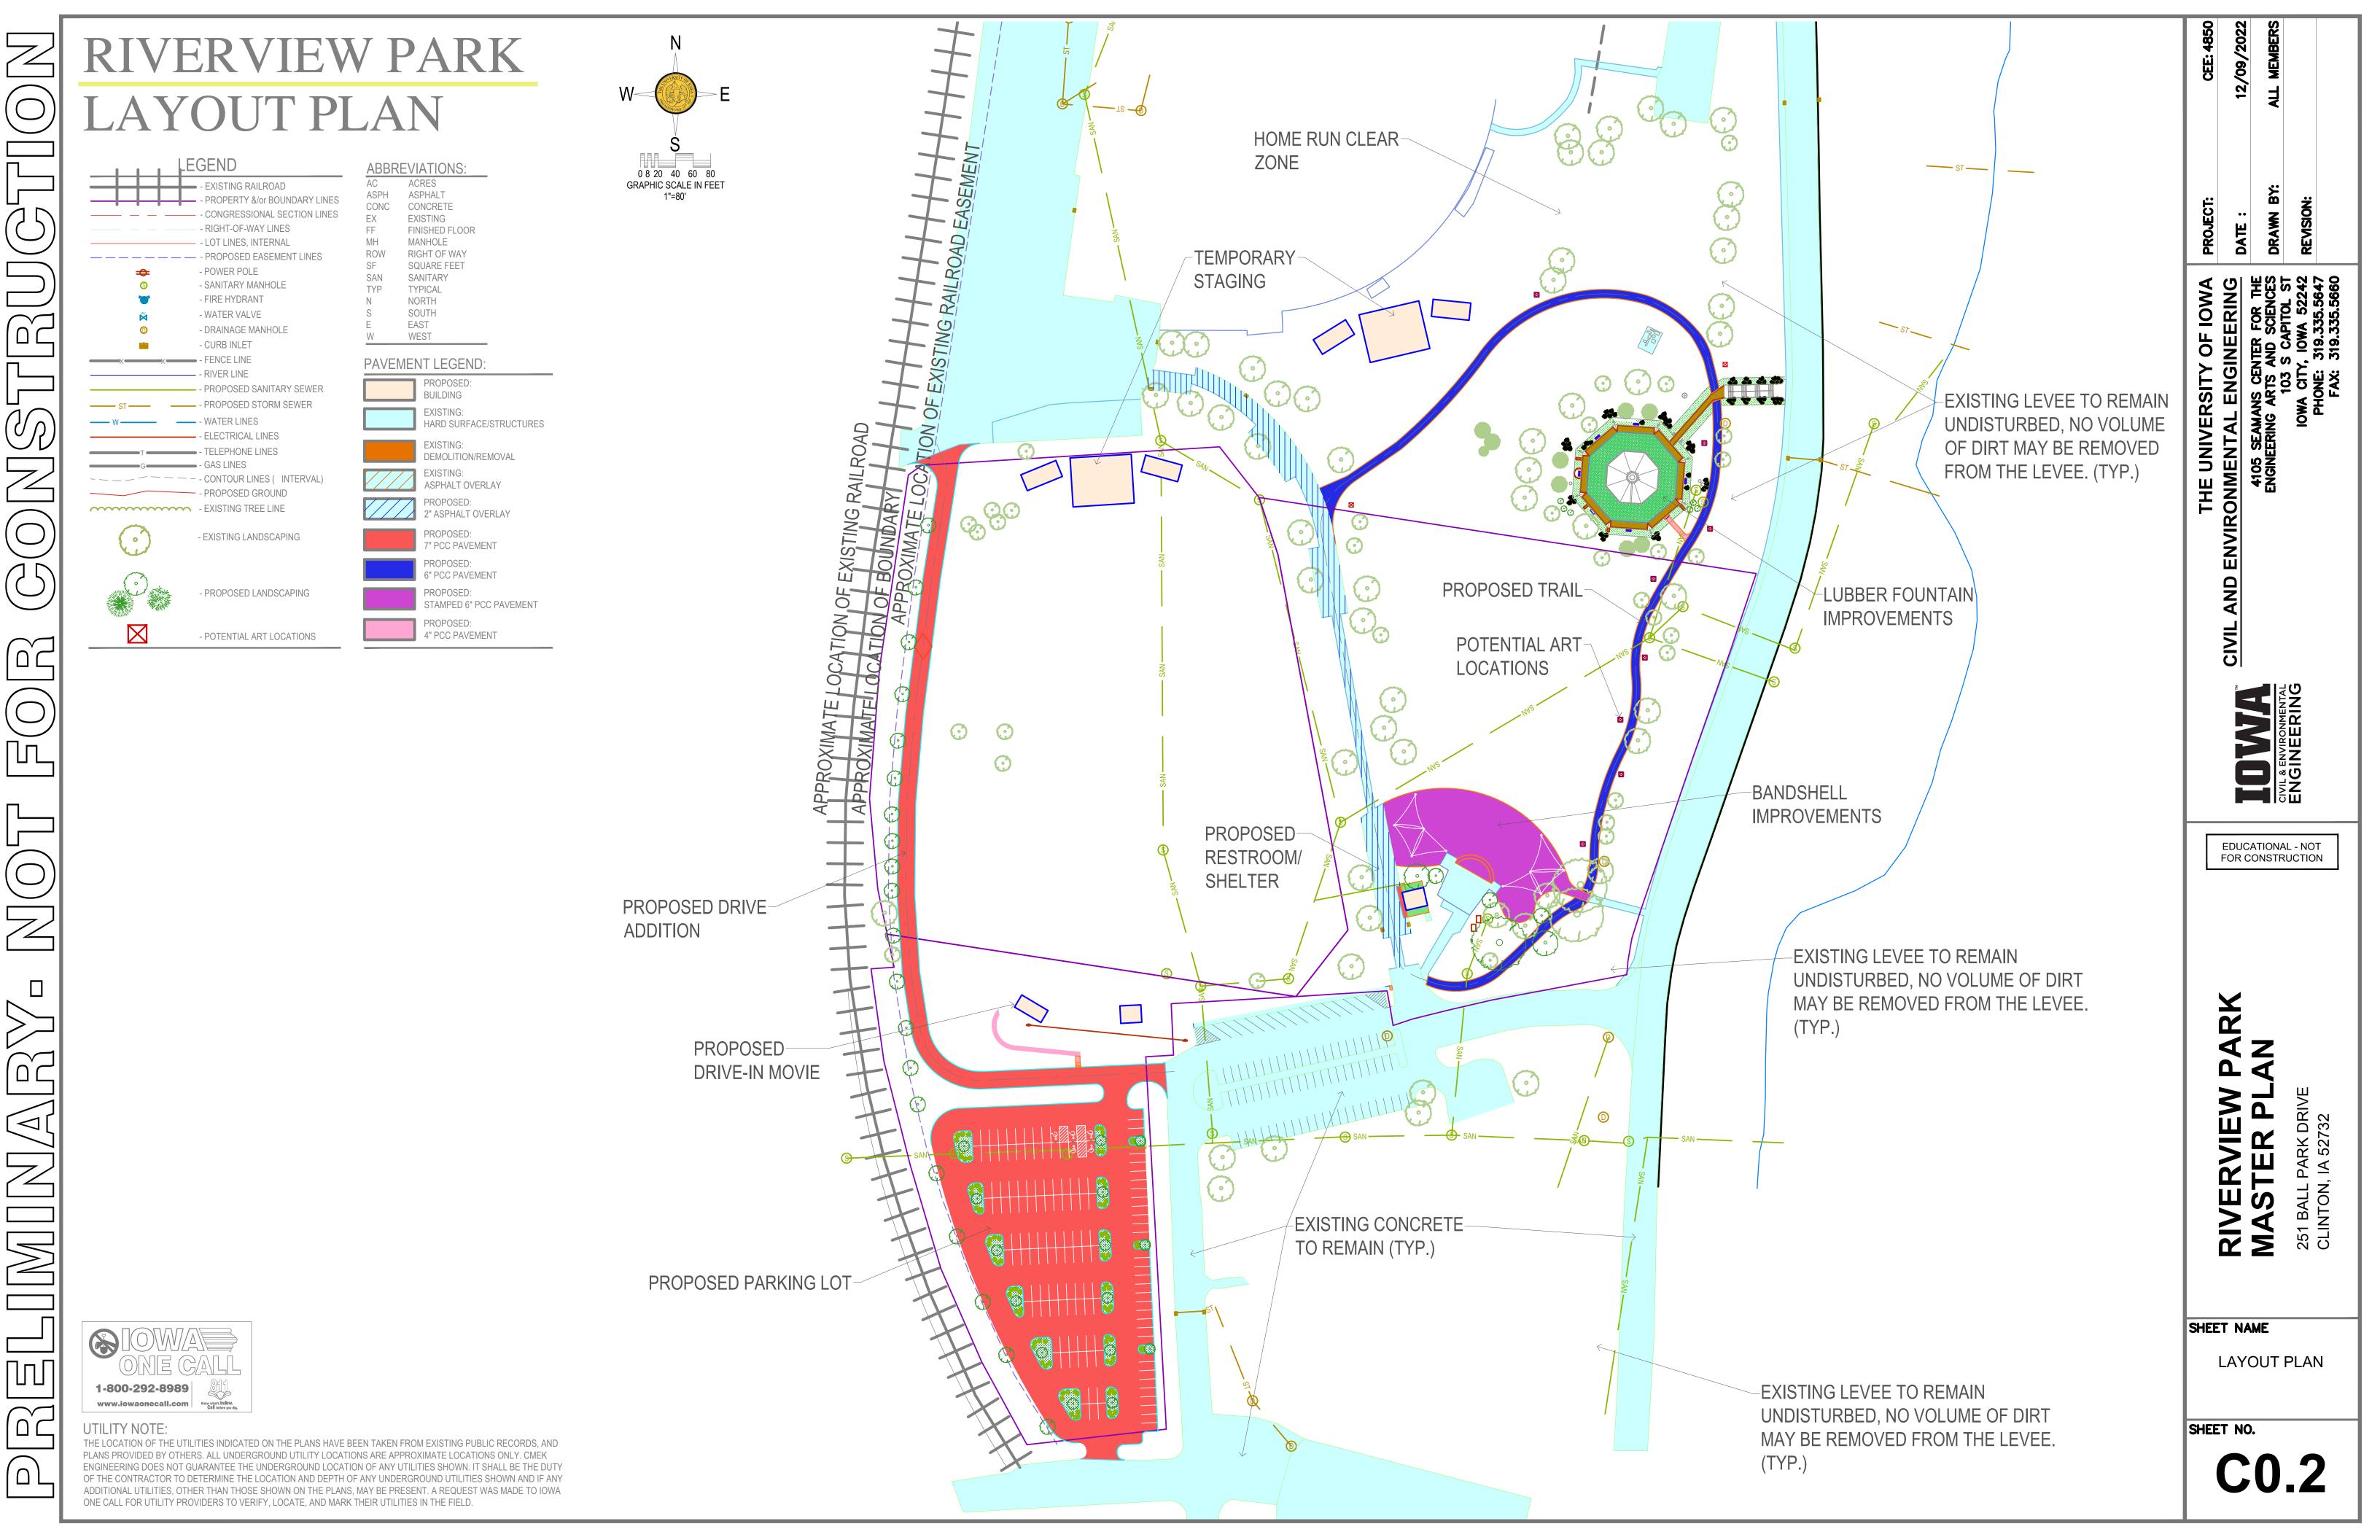


# RIVERVIEW PARK LUBBER FOUNTAIN DEMOLITION PLAN

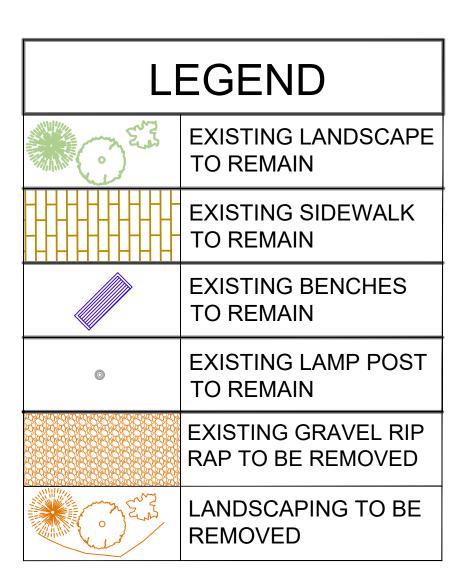

#### NOTES:

- 1. CONTRACTOR TO VERIFY ALL QUANTITIES, DIMENSIONS, ARRANGEMENTS AND CONDITIONS.
- 2. ALL WORK IS BASE BID UNLESS NOTED AS AN ALTERNATE.
- 3. F.V. MEANS FIELD VERIFIED BY CONTRACTOR.



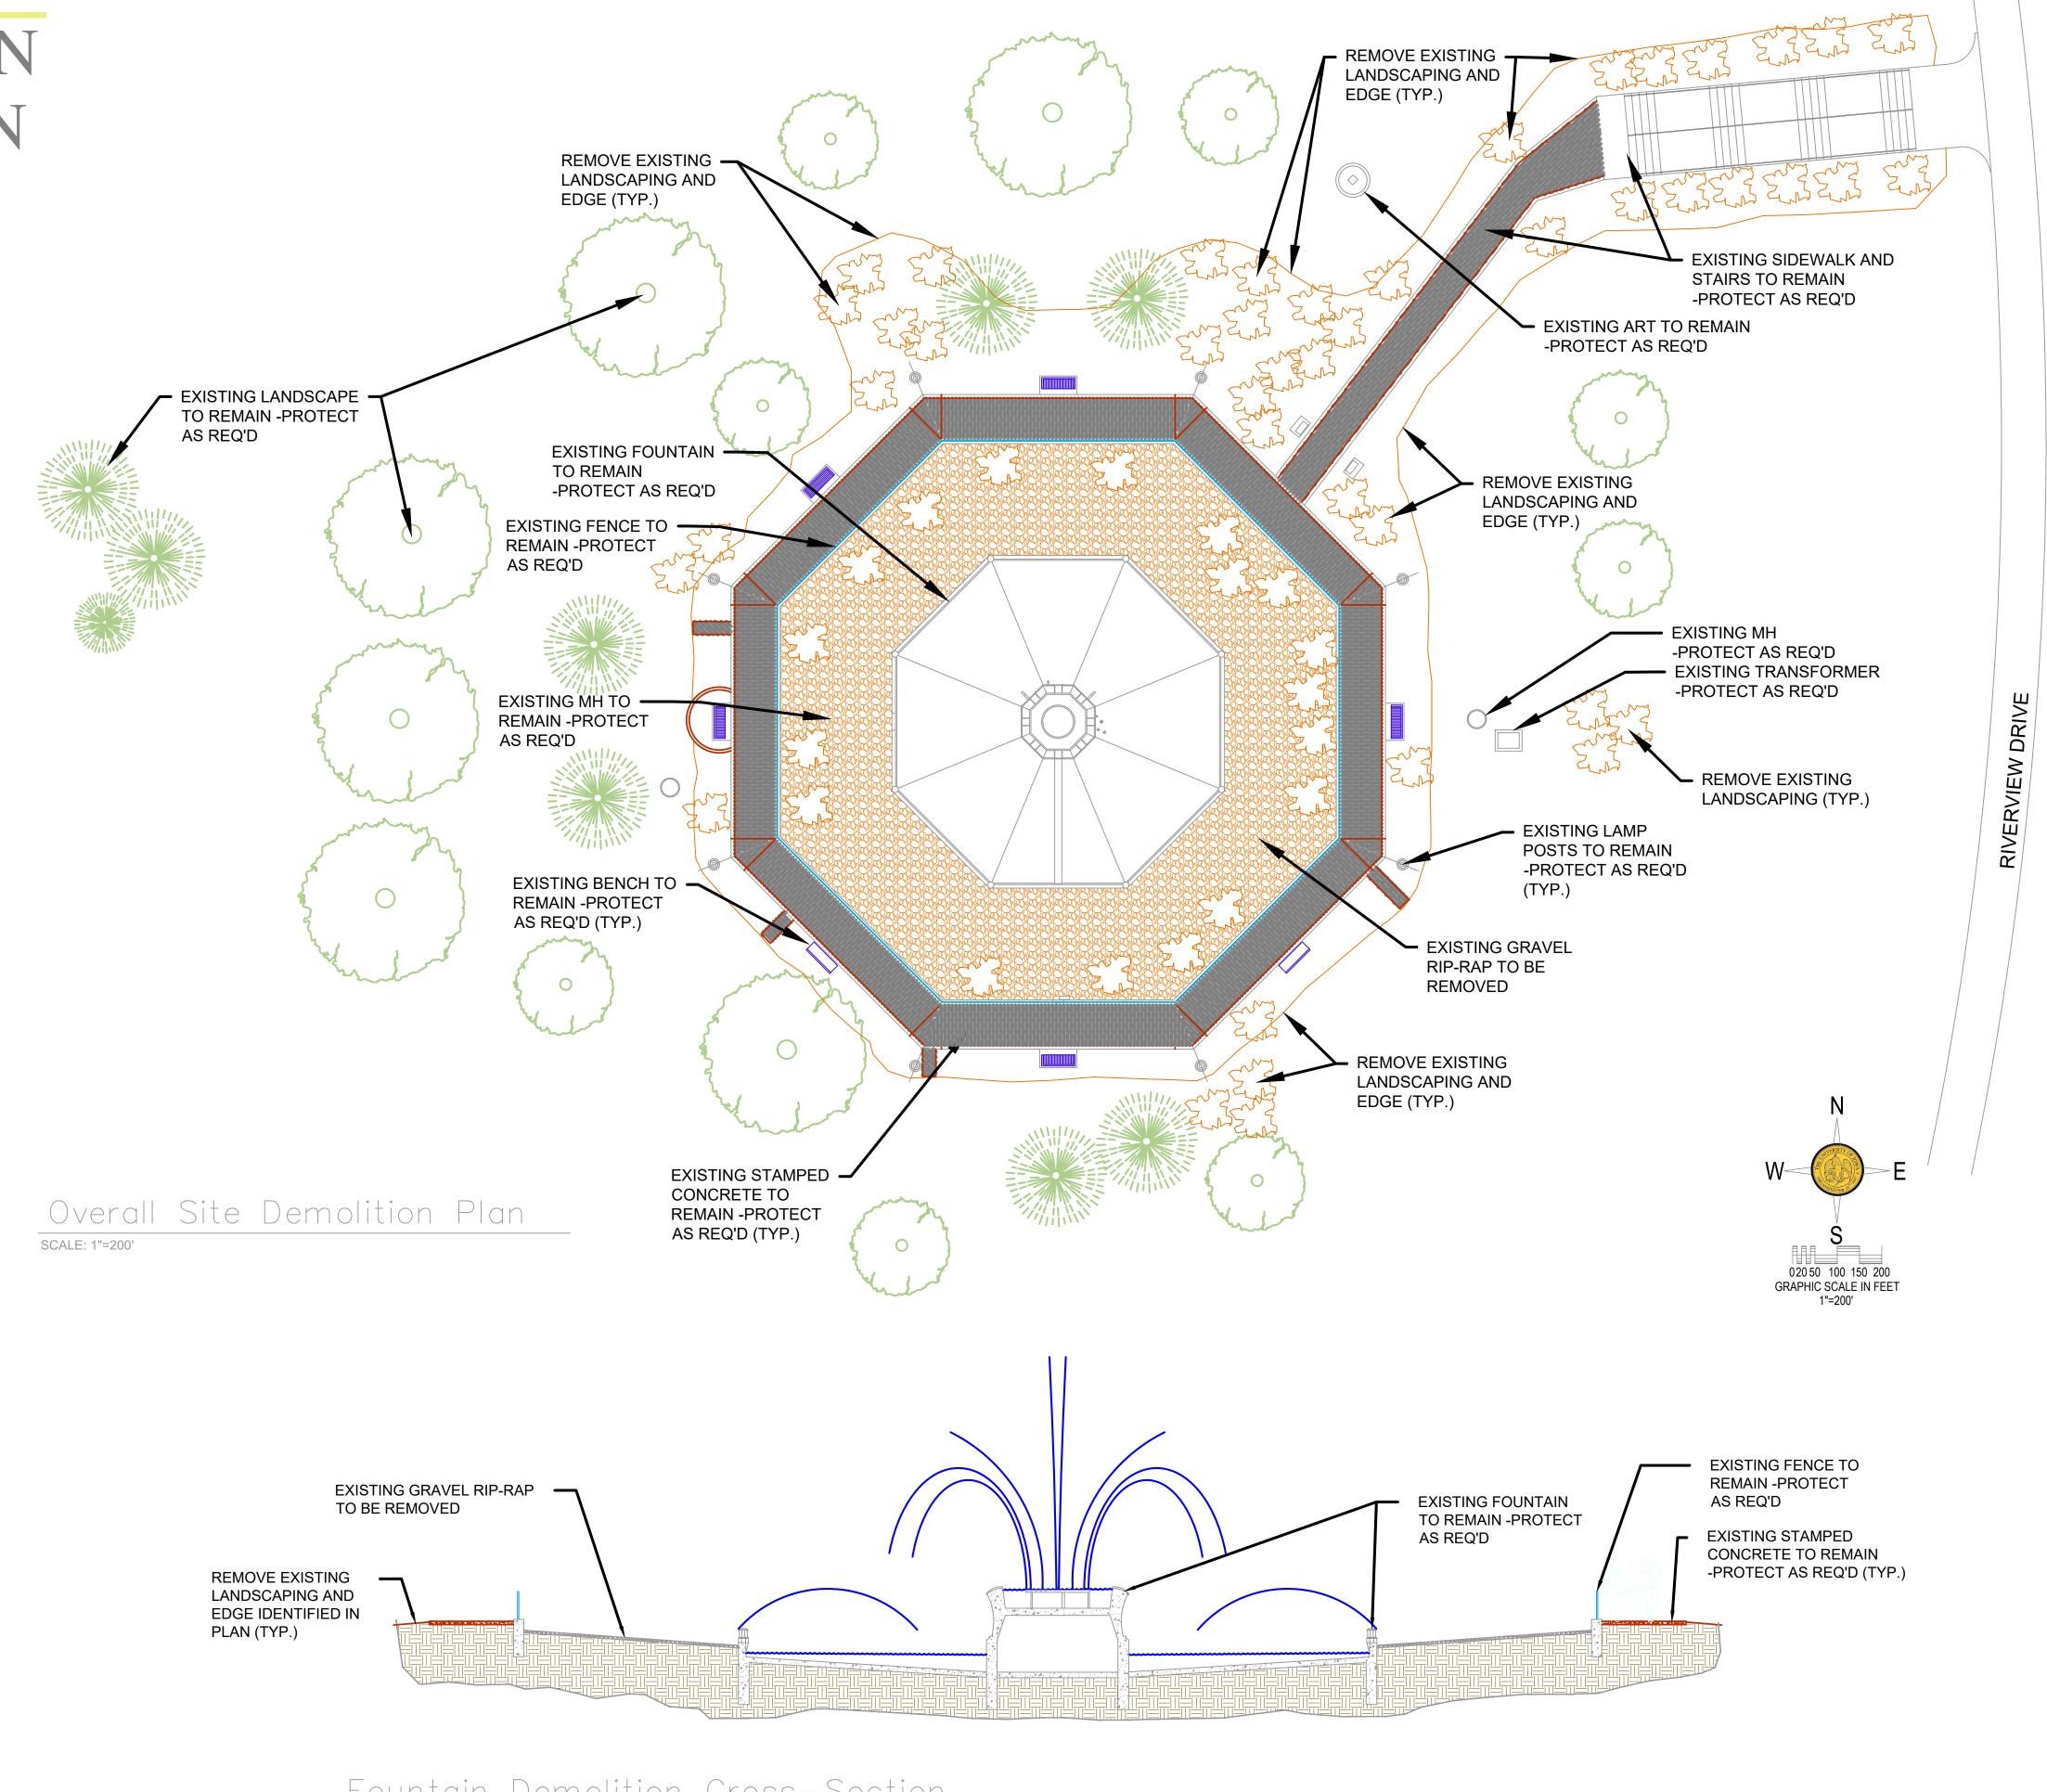

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RIVERVIEW PARI MASTER PLAN 251 BALL PARK DRIVE

SHEET NAME


LUBBER FOUNTAIN DEMOLITION PLAN

SHEET NO.


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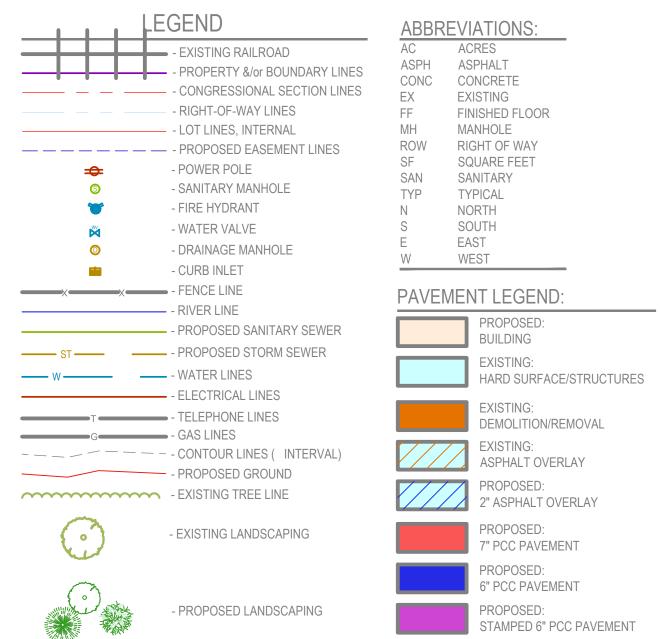
Fountain Demolition Cross-Section

SCALE: 1"=100'

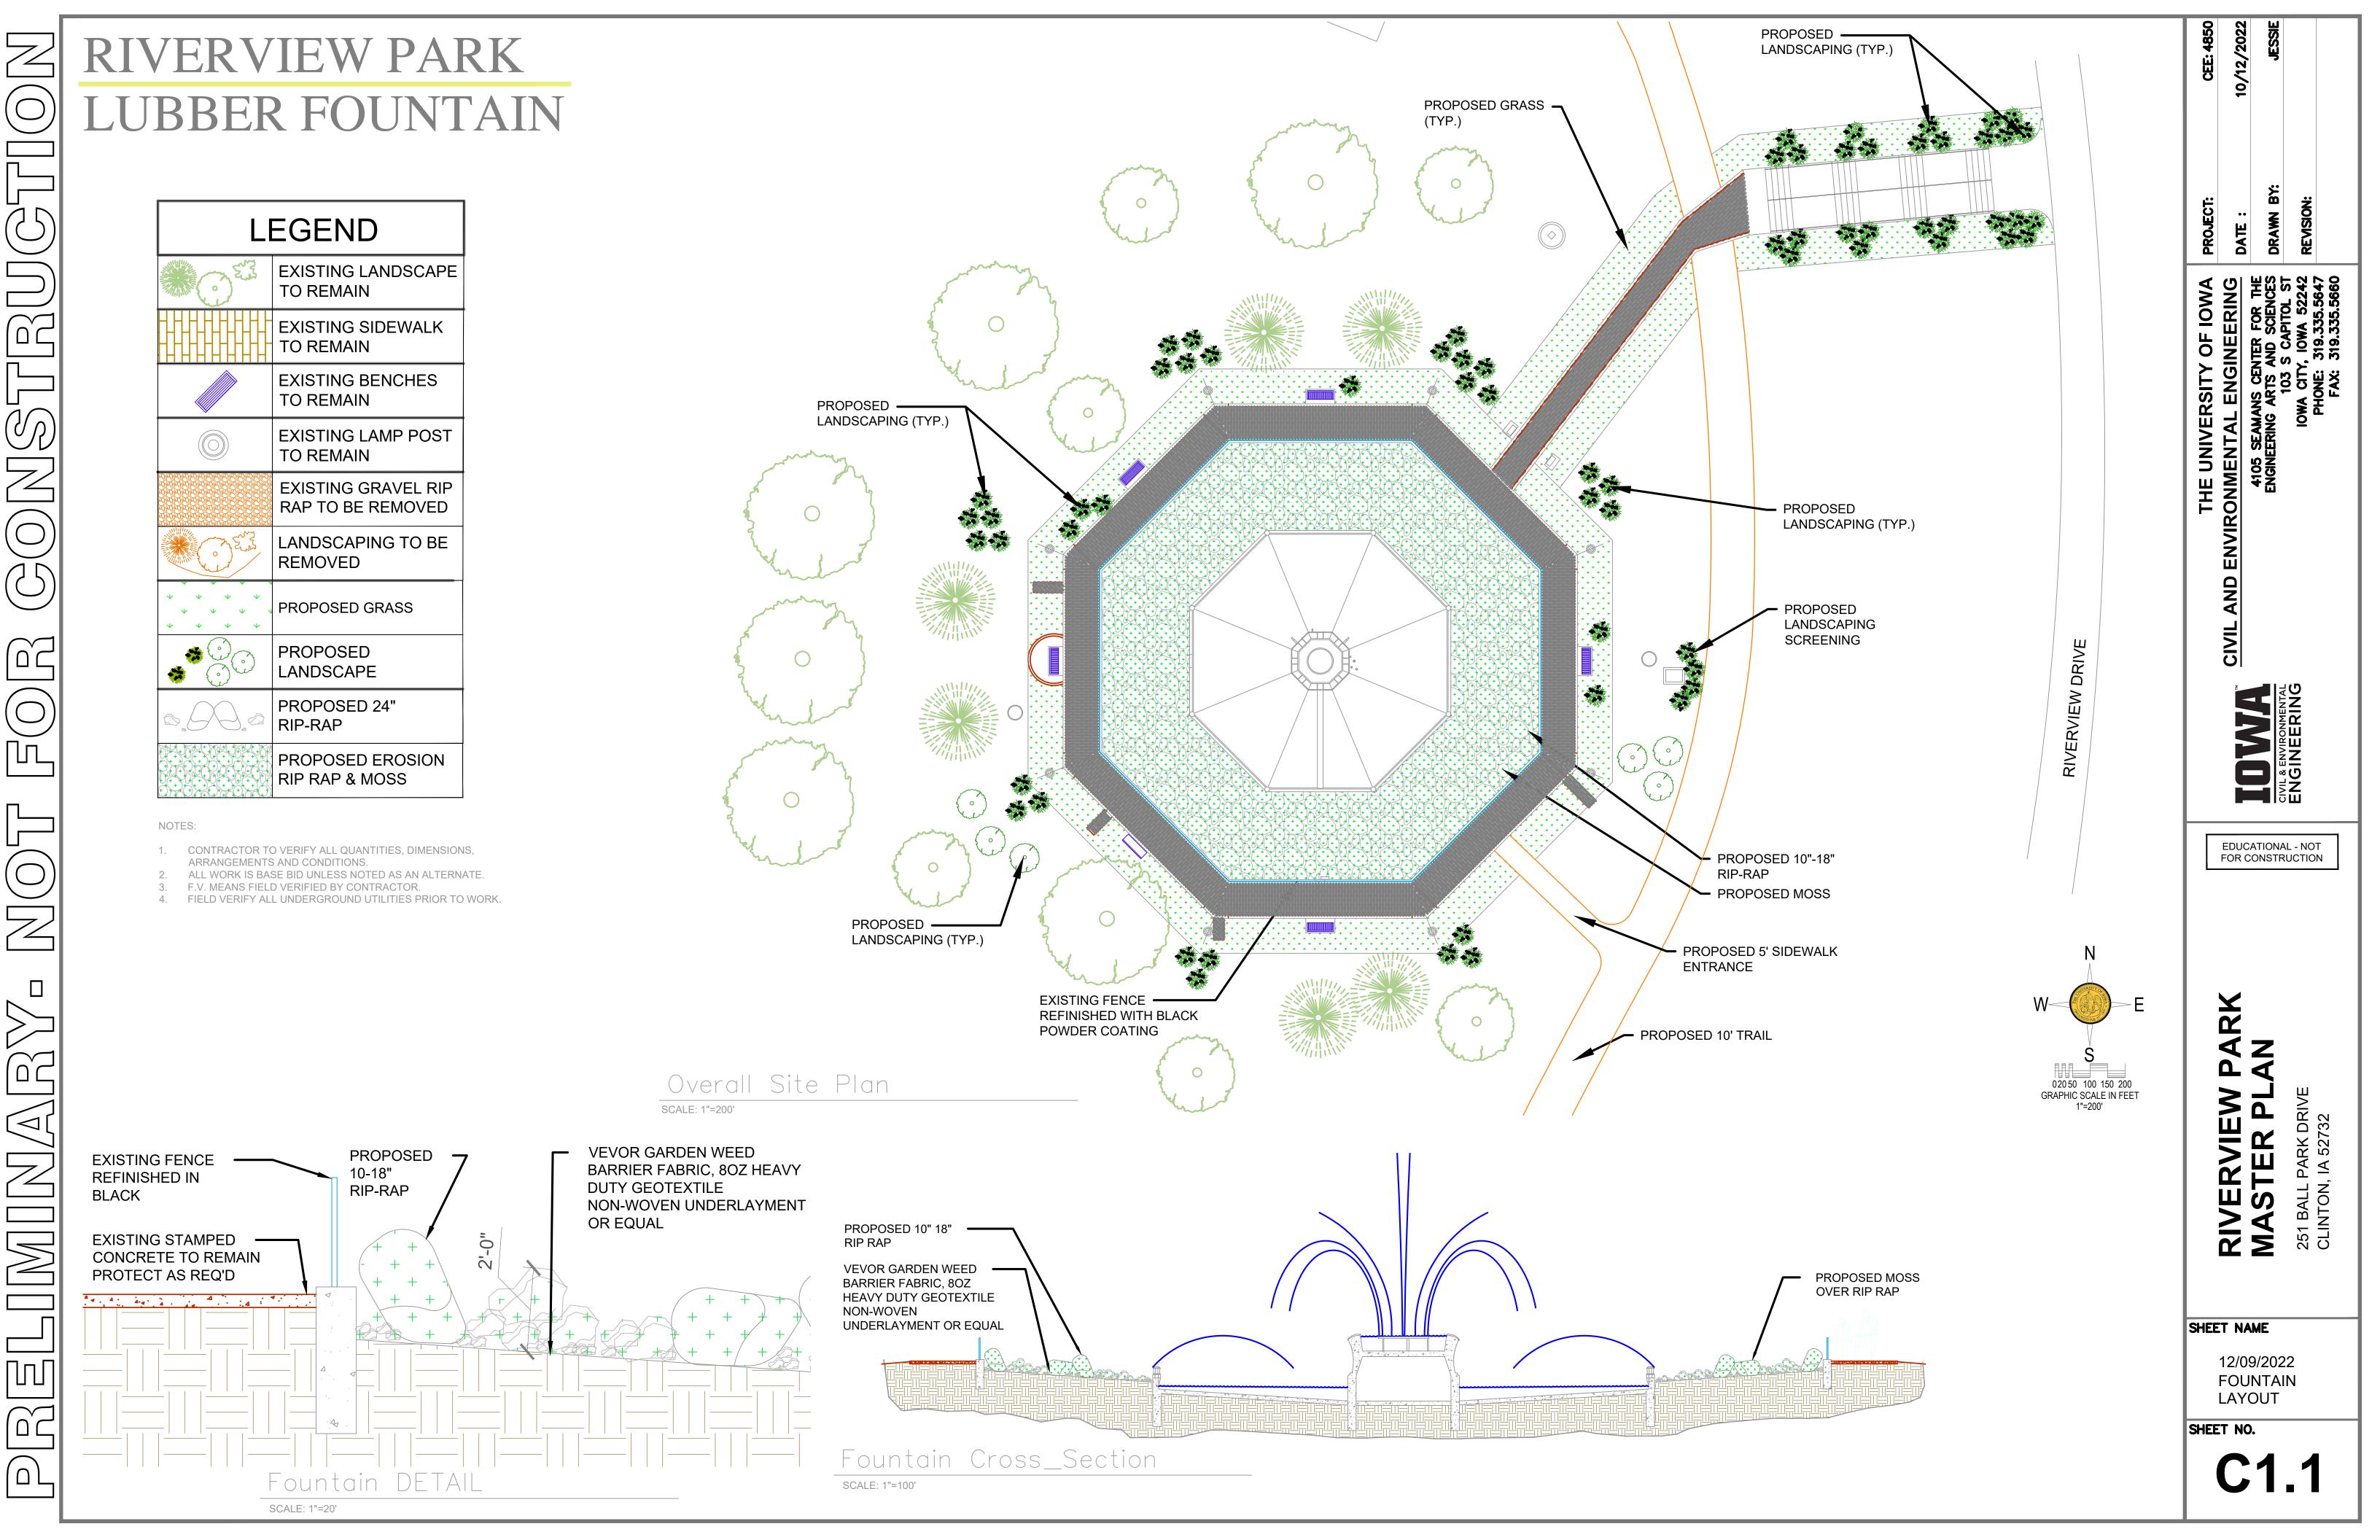

## RIVERVIEW PARK TRAIL/SIDEWALK DEMOLITION PLAN ABBREVIATIONS: ASPHALT - PROPERTY &/or BOUNDARY LINES




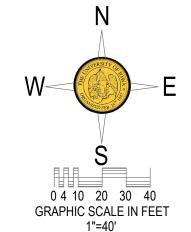





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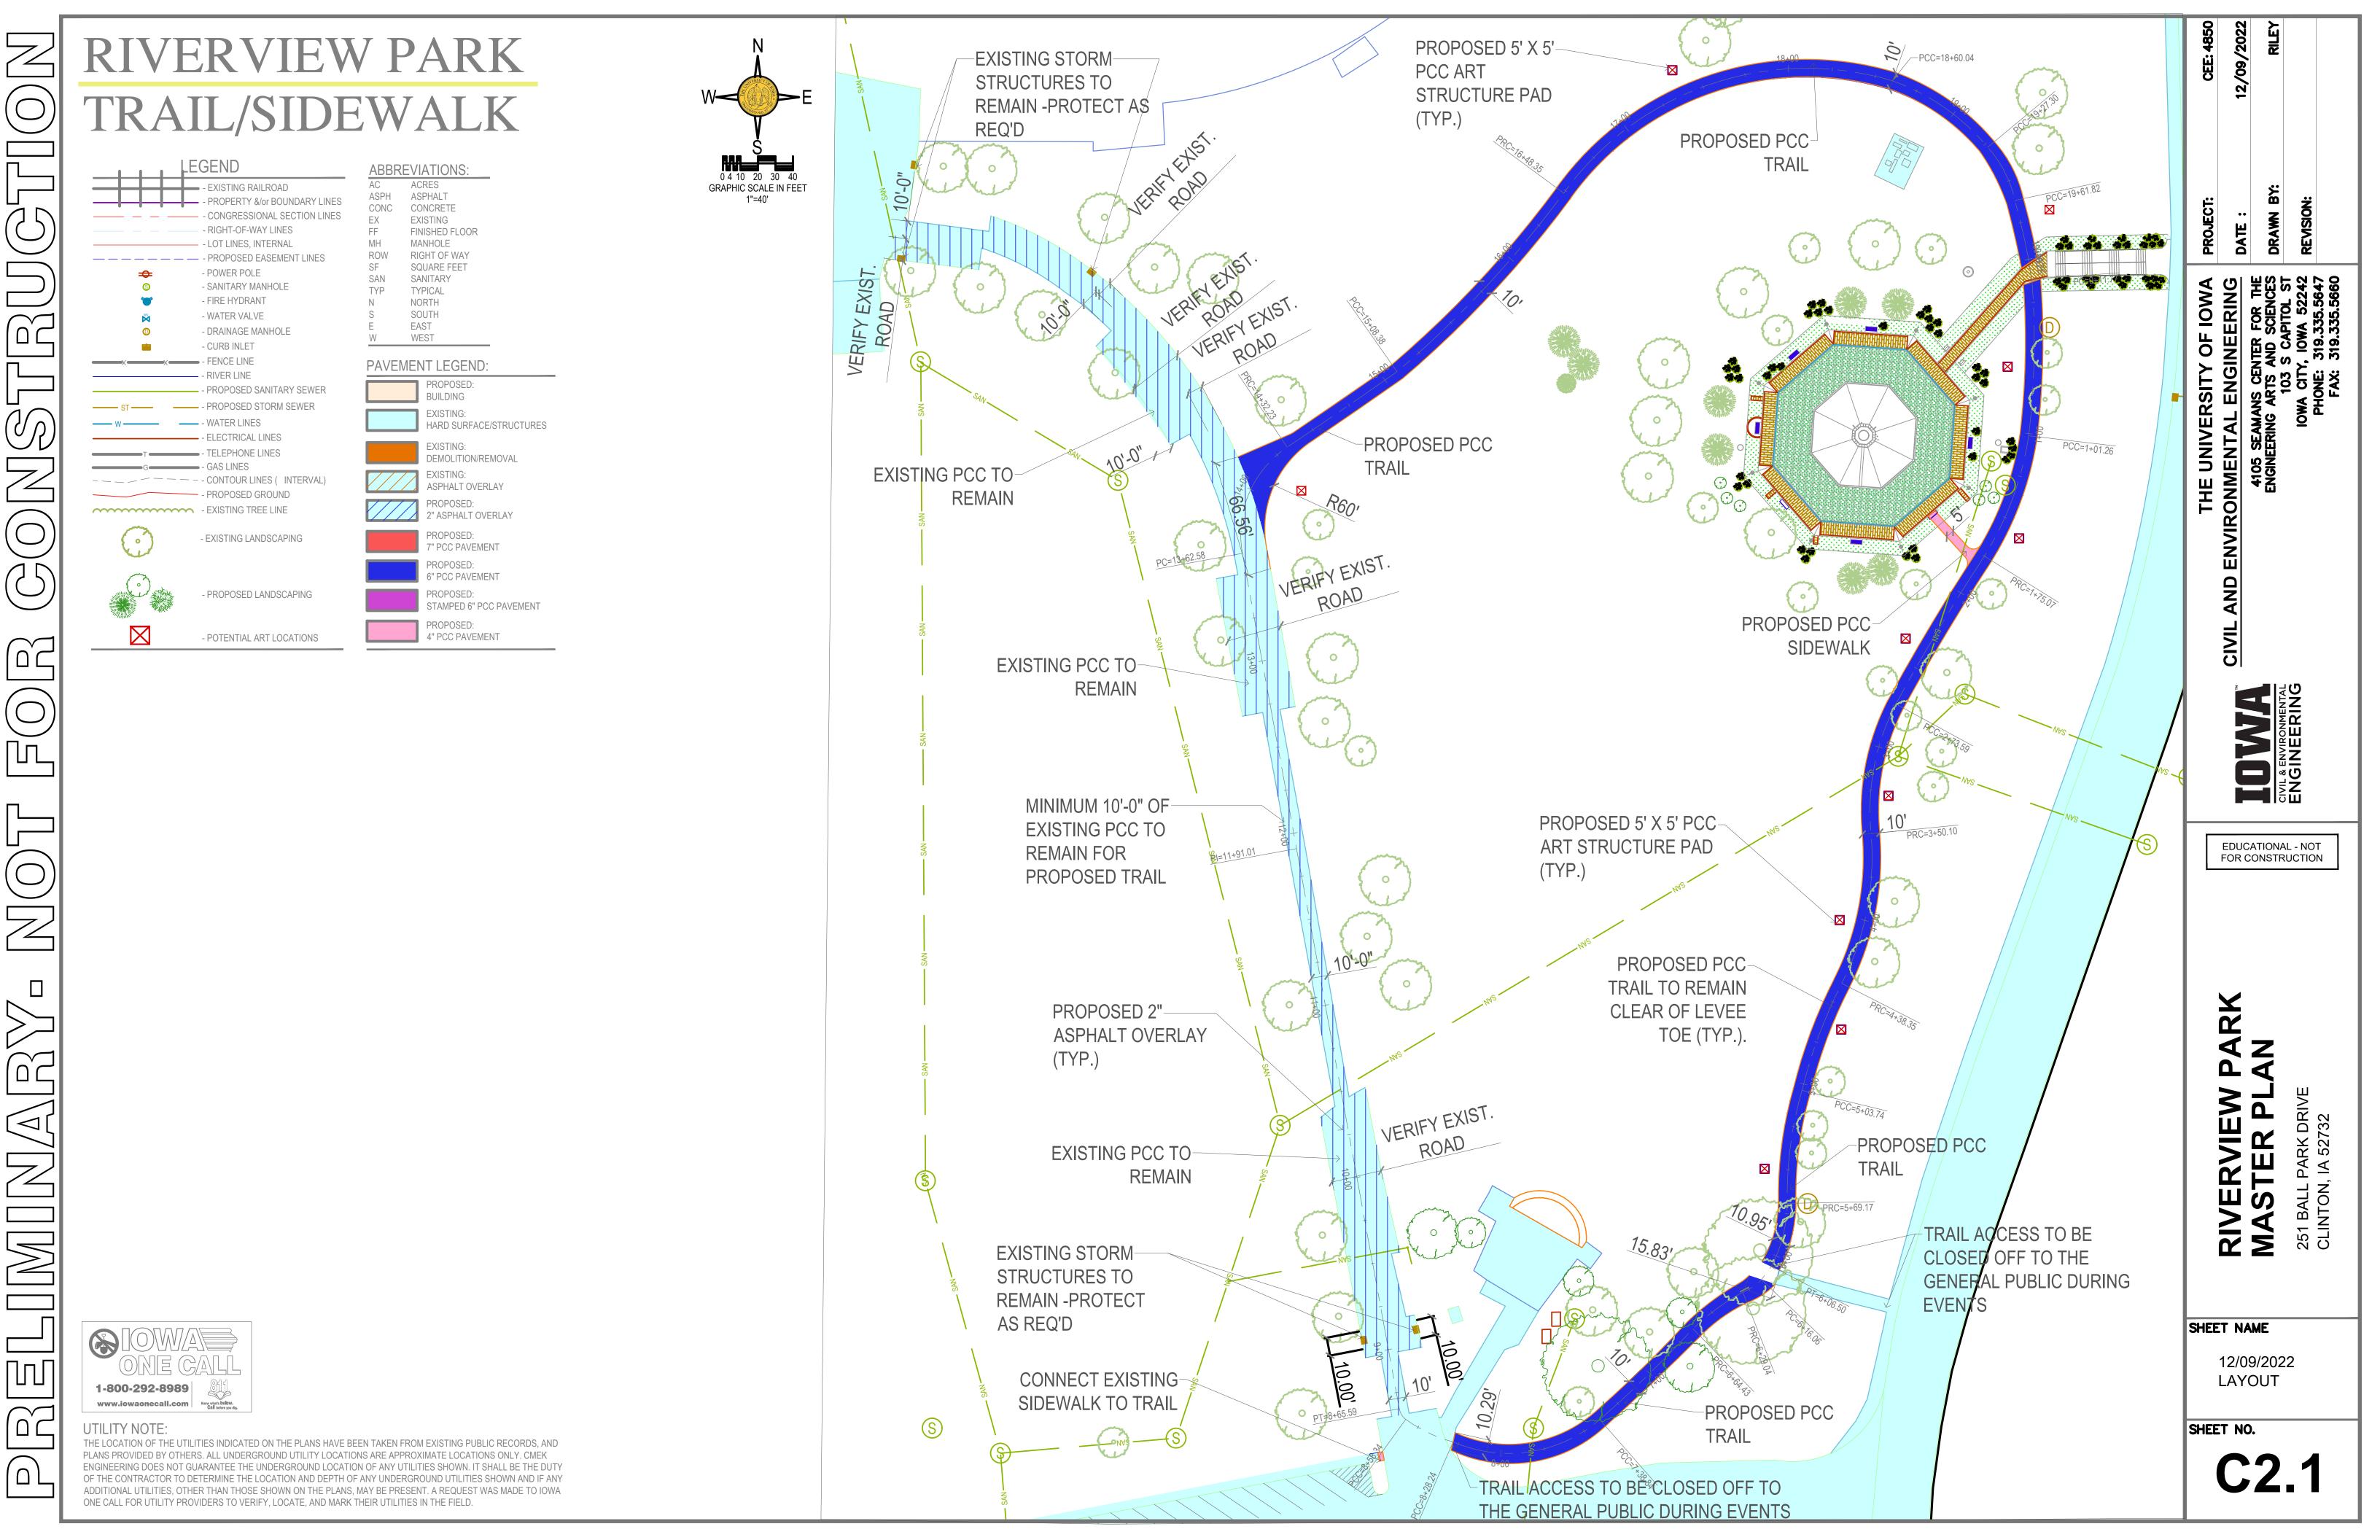
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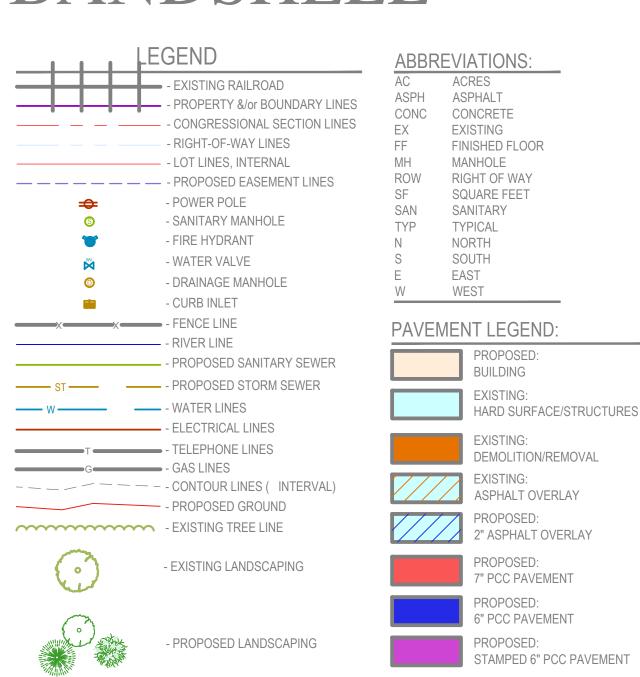
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TRAIL/SIDEWALK DEMOLITION PLAN

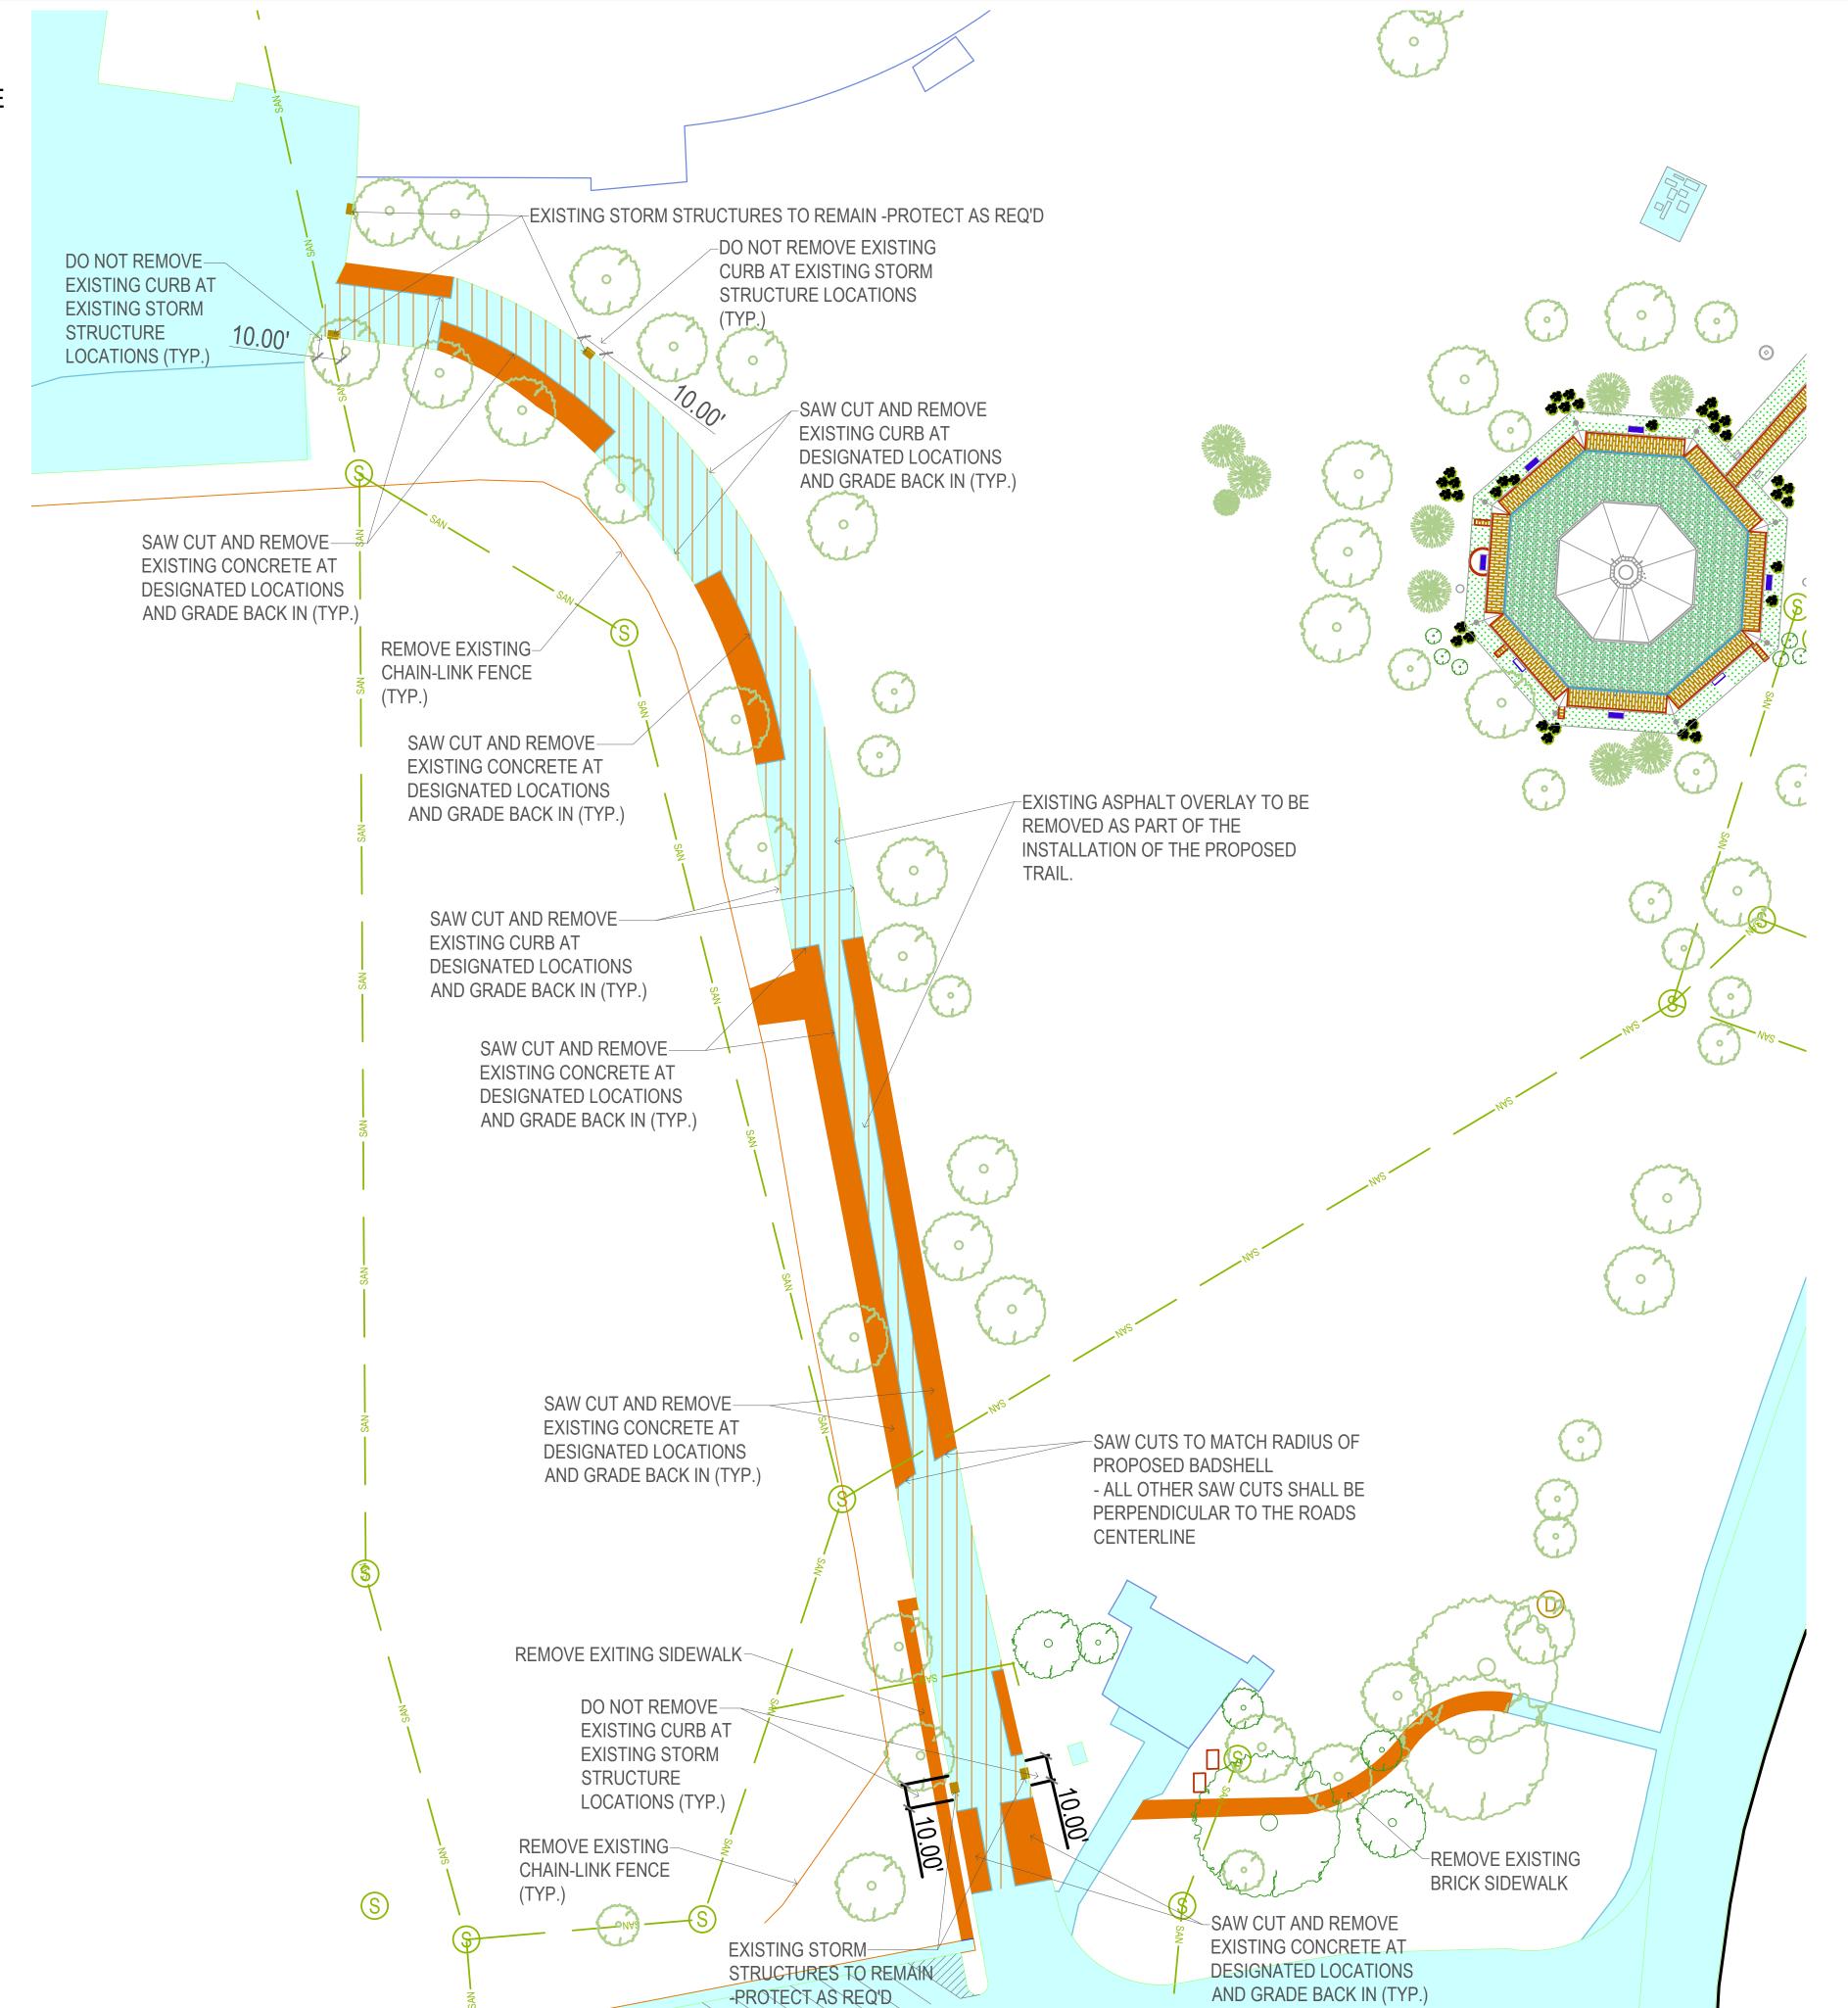SHEET NO.




## RIVERVIEW PARK BANDSHELL




- POTENTIAL ART LOCATIONS

PROPOSED: 4" PCC PAVEMENT

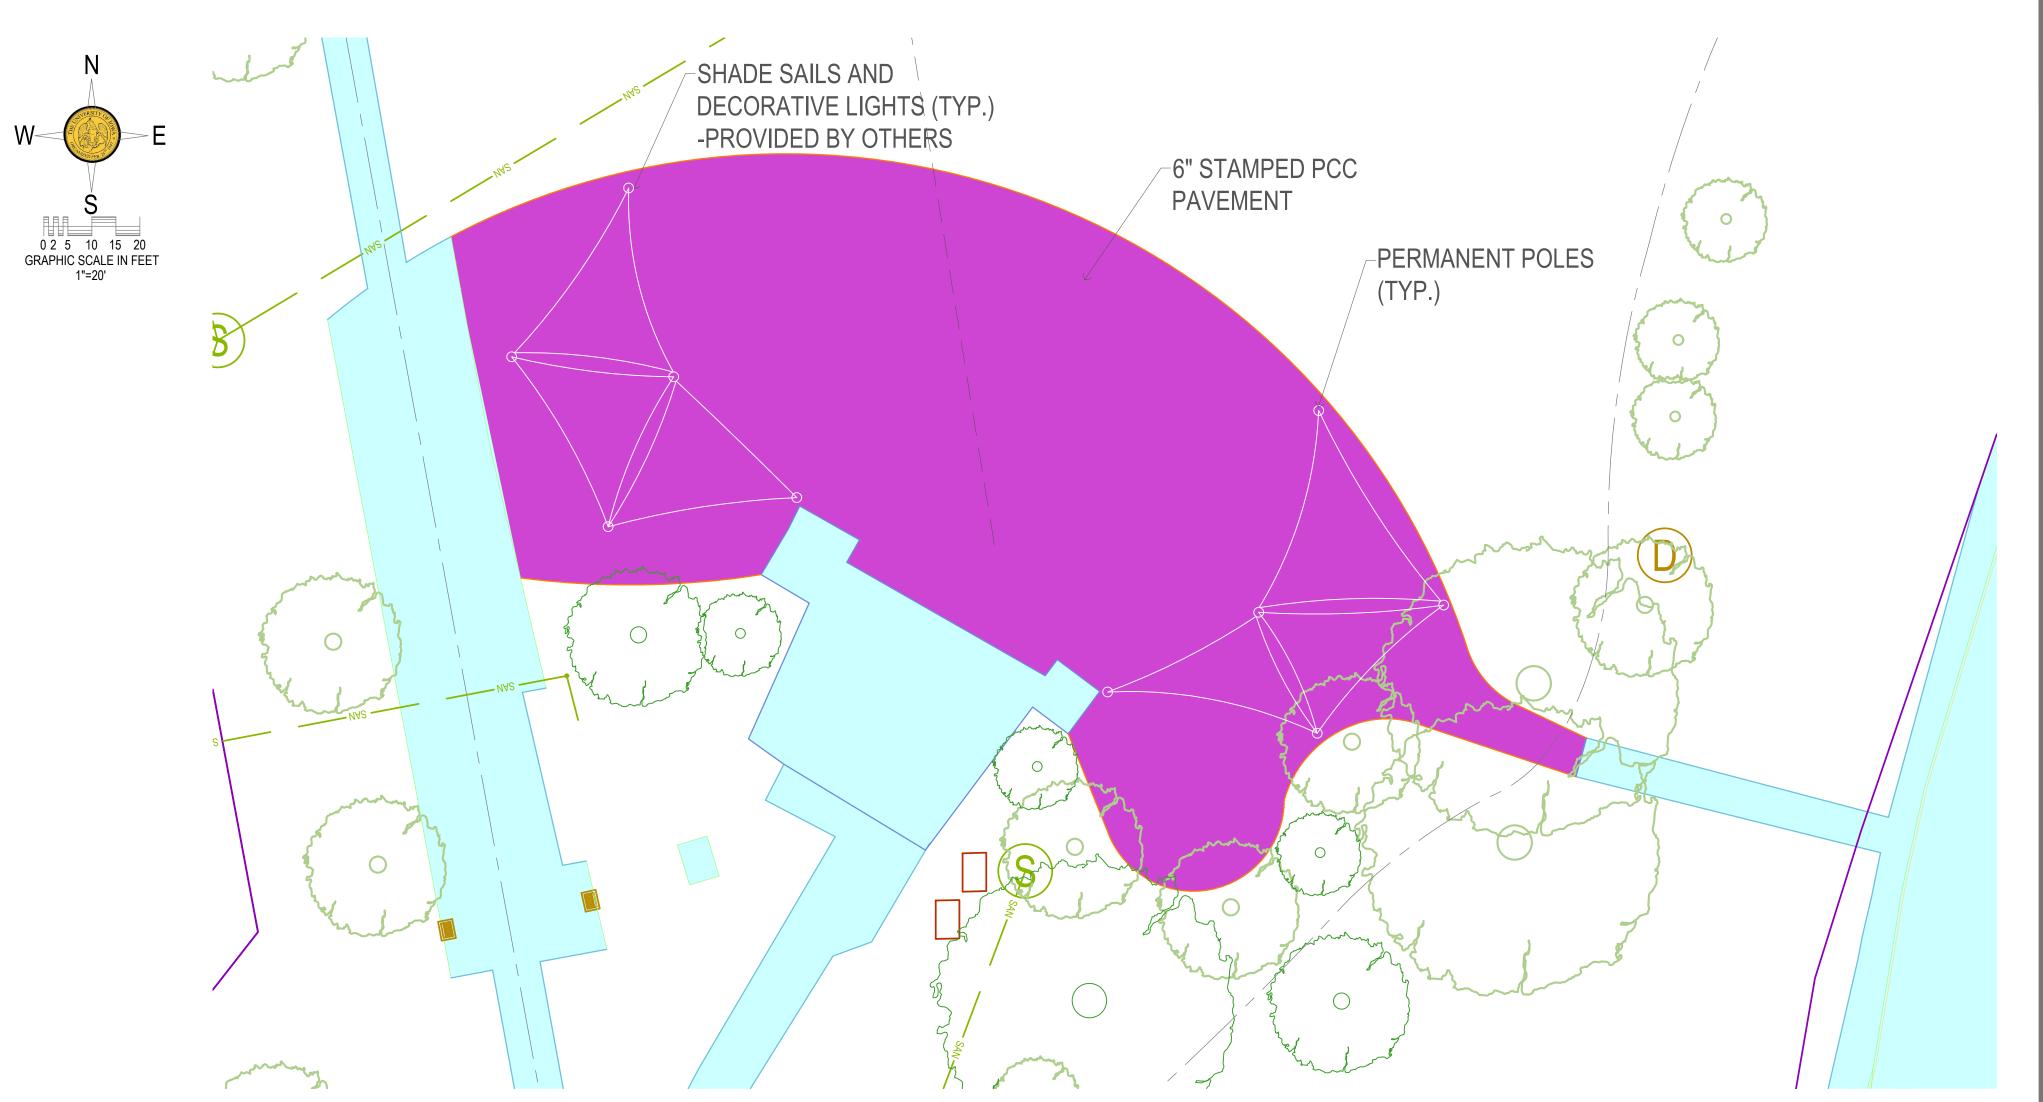



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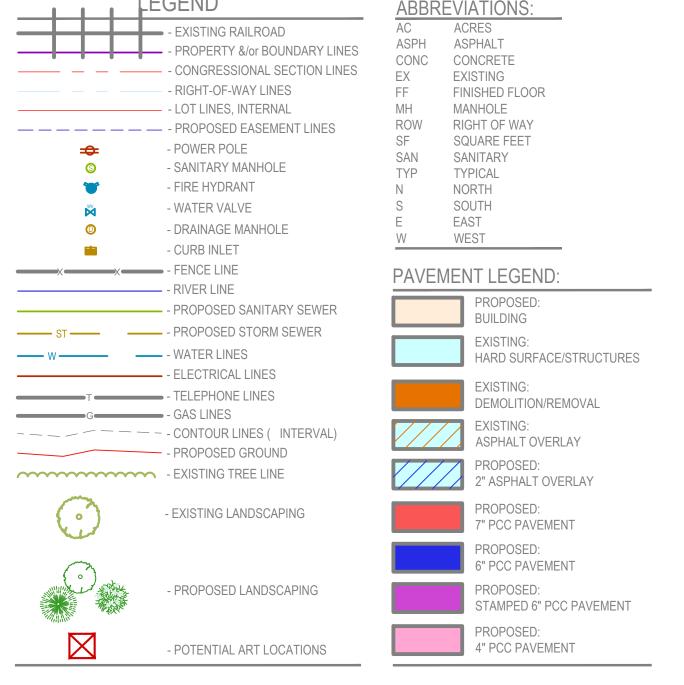
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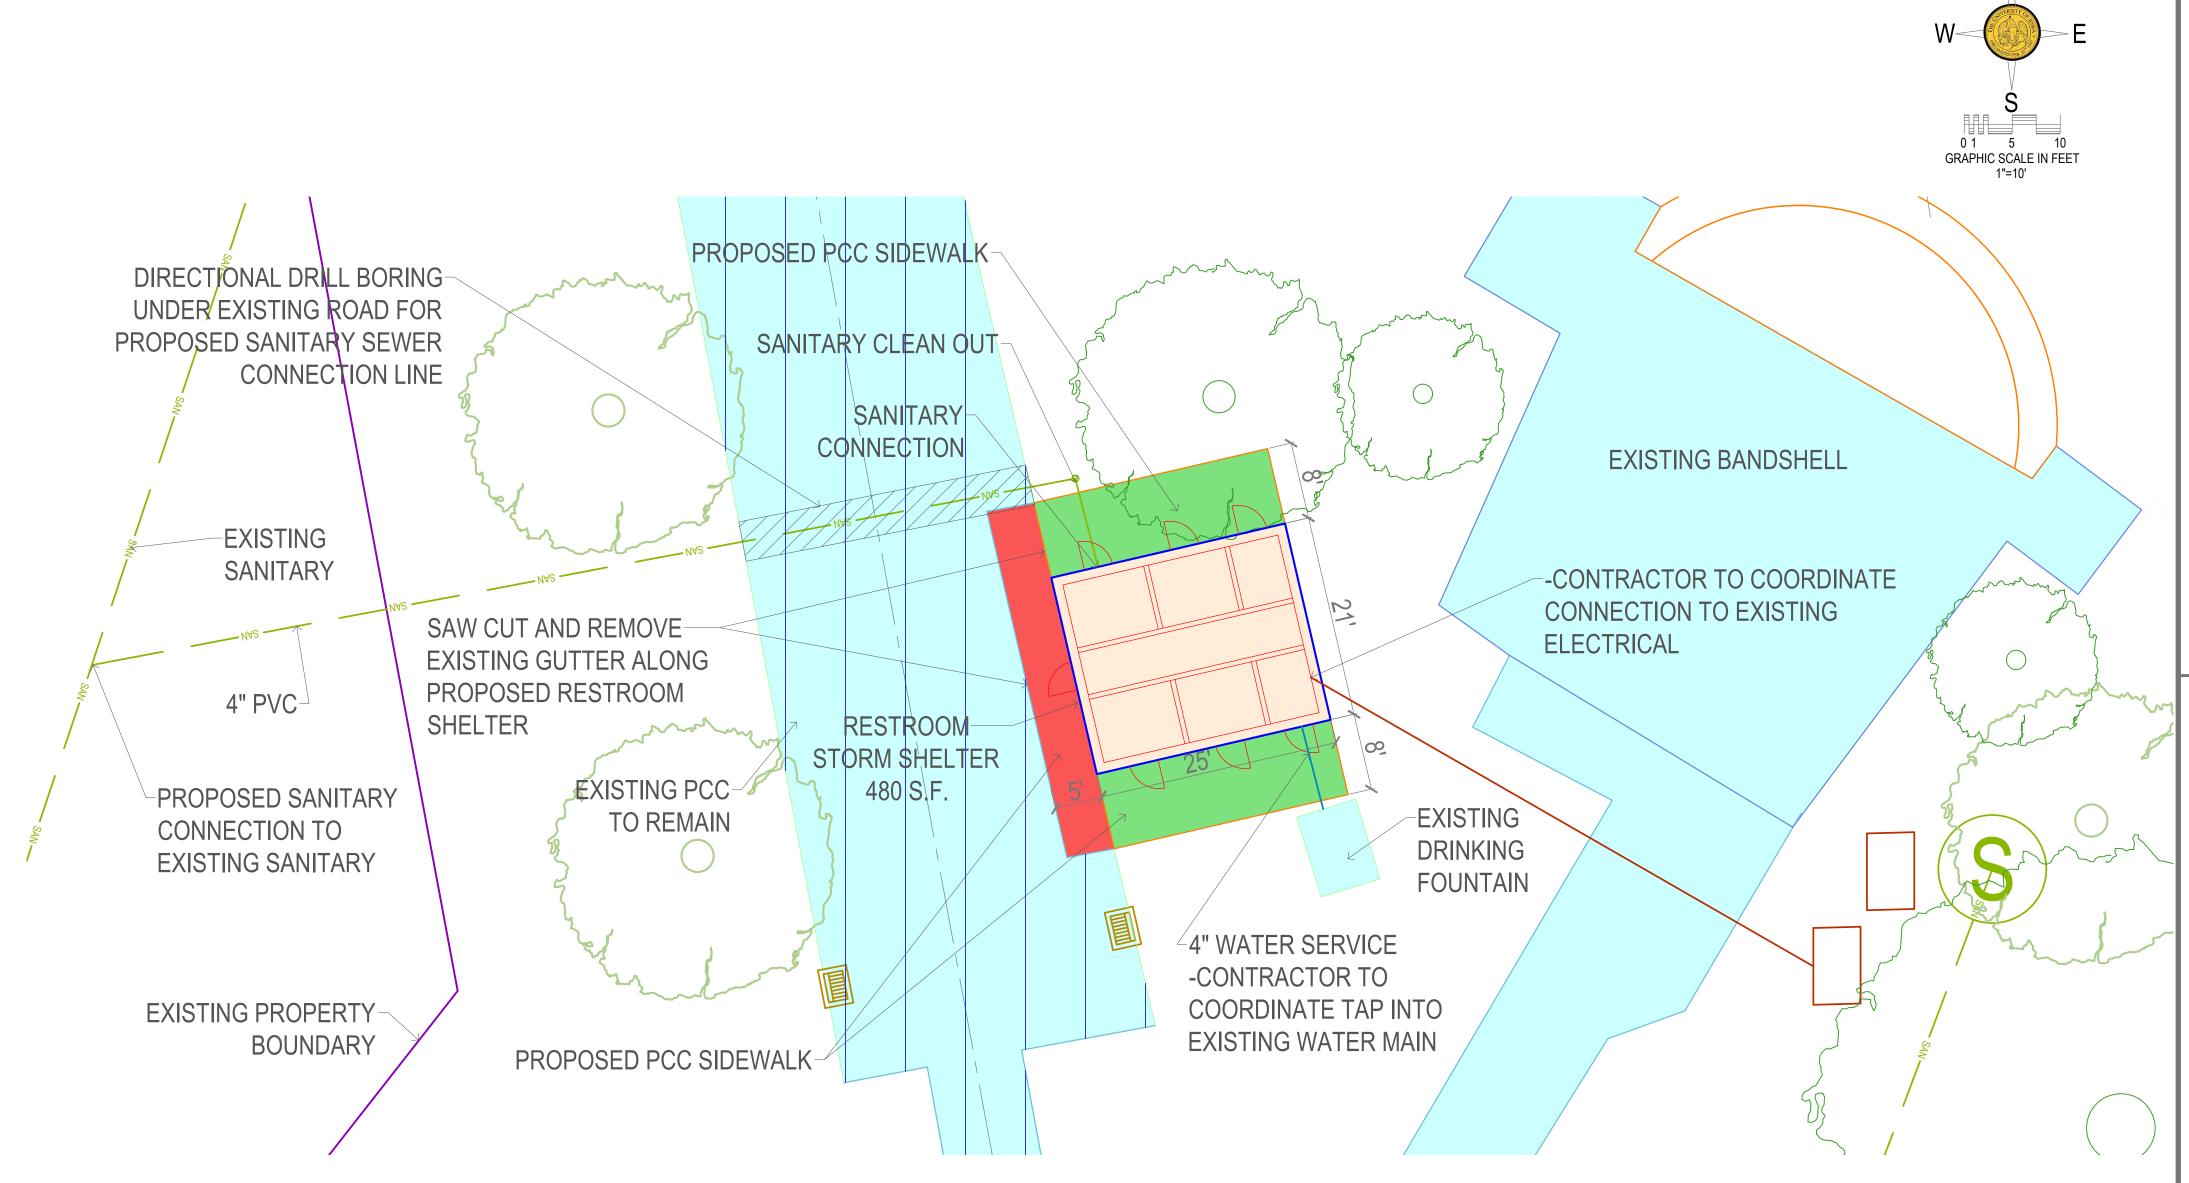
SHEET NAME

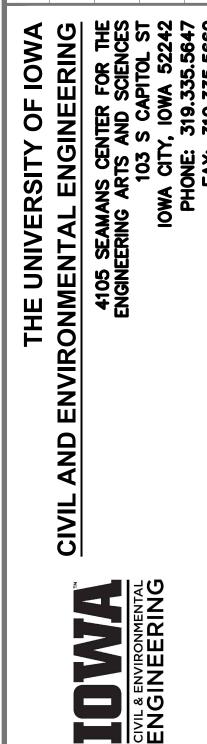BANDSHELL LAYOUT

SHEET NO.

## RIVERVIEW PARK RESTROOM, STORM SHELTER







UTILITY NOTE

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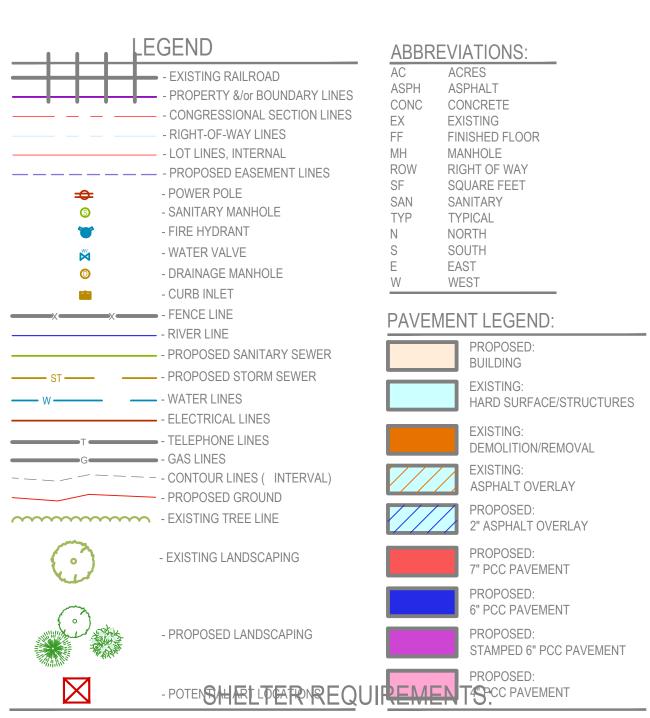
C4.0 STORM SHELTER

SHEET NO.

C4.0

## RIVERVIEW PARK RESTROOM, STORM SHELTER FLOOR PLAN

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ICC 500 STANDARD FOR THE DESIGN AND CONSTRUCTION OF STORM SHELTERS:

TORNADO SHELTERS HAVE A MINIMUM DURATION OF OCCUPANCY OF 2 HOURS.

STORM SHELTER IS CONSTRUCTED OUT OF CONCRETE OR CONCRETE MASONRY

CALCULATED SOIL PRESSURE UNDER THE SLABS-ON-GROUND SUPPORTING THE STORM SHELTER WALLS DOES NOT EXCEED 2,000 PSF (95.8KN/M^2) FOR DESIGN LOADING CONDITIONS OTHER THAN DESIGN STORM EVENTS AND 3,000 PSF (143.7 KN/M^2) FOR DESIGN STORM EVENTS

STORM SHELTER IS ANCHORED AT A MINIMUM TO THE SLAB-ON-GROUND AT EACH CORNER OF THE STRUCTURE AND ON EACH SIDE OF DORM OPENINGS IN THE SHELTER ENVELOPE.

ALL EXPOSED COMPONENTS AND CLADDING ASSEMBLIES AND ROOF COVERINGS OF TORNADO SHELTERS SHALL MEET THE REQUIREMENTS OF THE APPLICABLE CODE.

EXTERIOR DOORS TO THE BUILDING SHALL HAVE A WEATHER SEAL PROVIDED AT THE UNDERCUT.

TORNADO SHELTERS SHALL BE PROVIDED WITH NATURAL VENTILATION OR WITH MECHANICAL VENTILATION (SECTION 702.4.1 AND 702.4.2). OPENINGS USED FOR ATMOSPHERIC PRESSURE CHANGE (APC) ARE PERMITTED TO BE COUNTED AS VENTILIATION.

#### TELEMETRY REQUIREMENTS:

TELEMETRIC LOCKS TO DISENGAGE WITH TORNADO SIRENS. KEYS TO BE HELD BY EMPLOYEES OF THE PARK IN CASE OF

#### LOAD REQUIREMENTS:

LOAD COMBINATIONS: ICC 500 STORM SHELTER LOAD COMBINATIONS DO NOT INCLUDE SNOW LOADS BECAUSE TORNADO AND HURRICANES OCCUR DURING WARM WEATHER. HOWEVER, SNOW LOADS MUST BE INCLUDED AS REQUIRED BY THE APPLICABLE CODE WHEN CHECKING THE NON-STORM SHELTER LOAD COMBINATIONS.

RAIN LOADS: THE STANDARD DOES NOT PROVIDE ADDITIONAL RAIN LOAD REQUIREMENTS FOR TORNADO STORM SHELTERS, SO TORNADO SHELTERS AND SAFE ROOMS ARE ONLY REQUIRED TO COMPLY WITH THE APPLICABLE CODE FOR RAIN LOADS WHERE REQUIRED BY THE NORMAL-USE LOAD COMBINATIONS.


ROOF LIVE LOADS MINIMUM: ICC 500-2020 REQUIRES LIVE LOADS TO COMPLY WITH APPLICABLE CODE, BUT NOT LESS THAN 100 POUNDS PER SQUARE FOOT (4.8KN/M^2)

FLOOR LOAD MINIMUM: AS A RESULT, ICC 500-2020 REQUIRES TORNADO STORM SHELTER FLOOR LIVE LOADS TO BE NO LESS THAN THE APPLICABLE CODE REQUIRES FOR ASSEMBLY OCCUPANCIES

WIND LOAD: SAFE ROOM DESIGN WIND SPEED OF 250 MPH.

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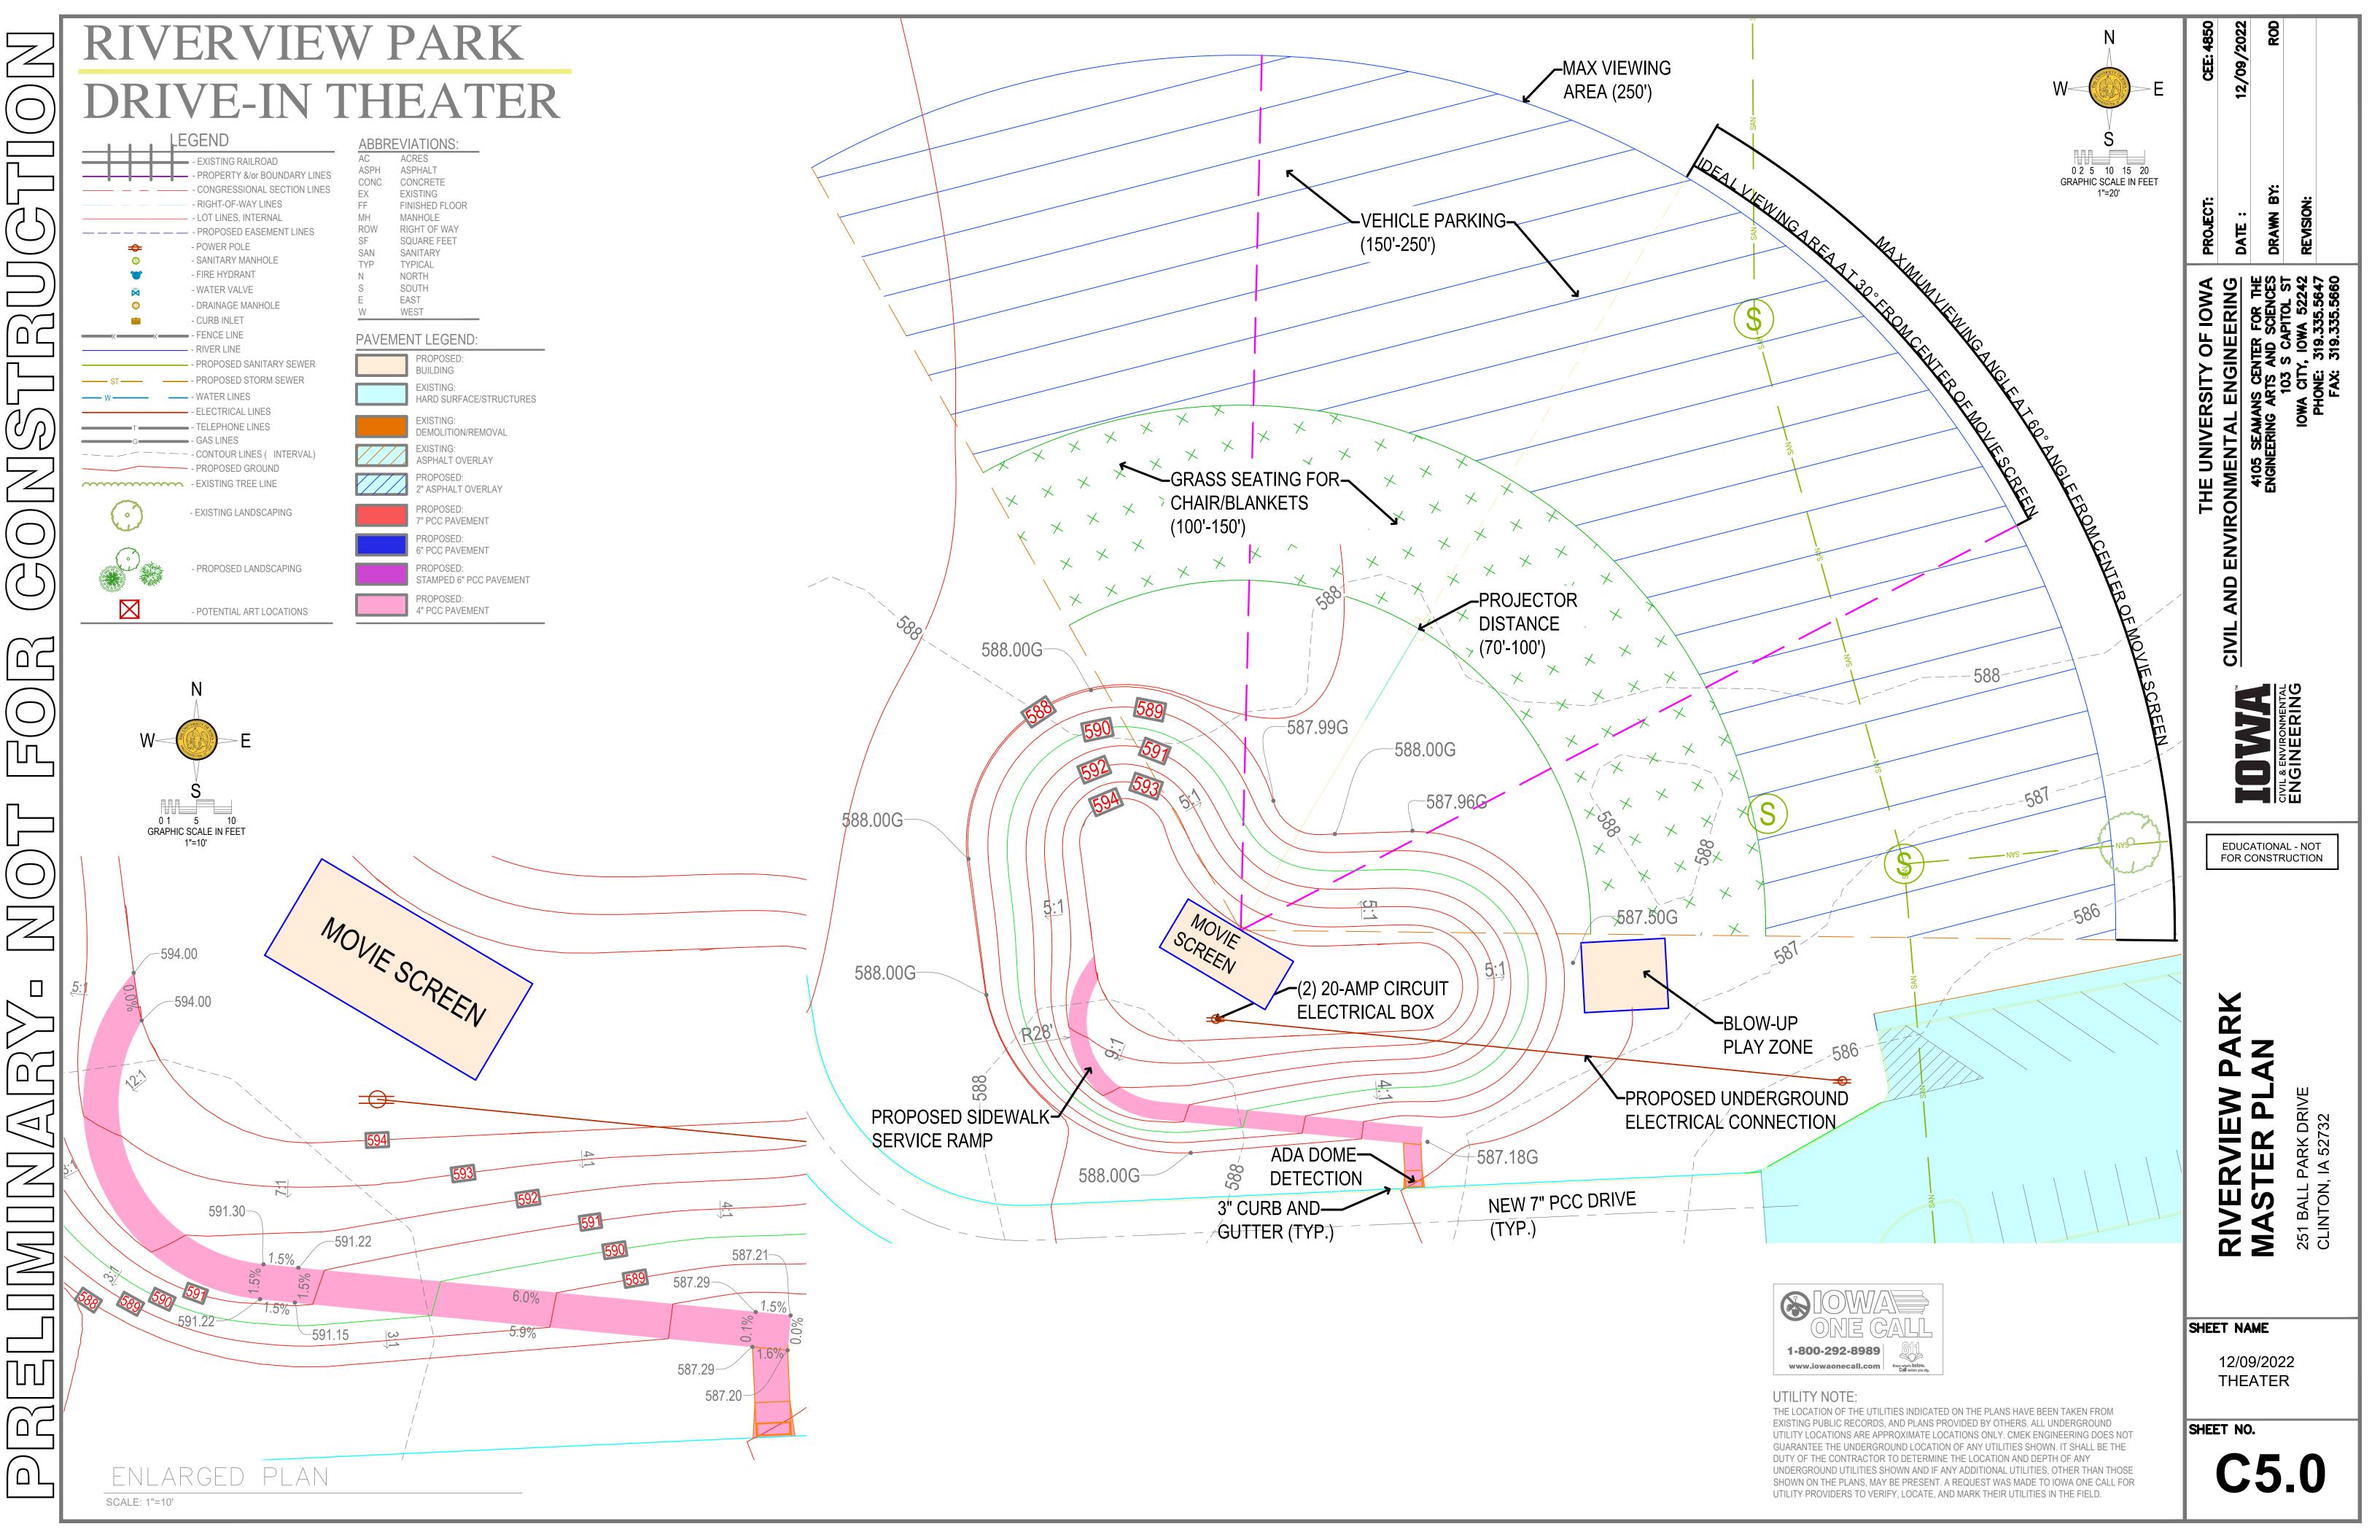
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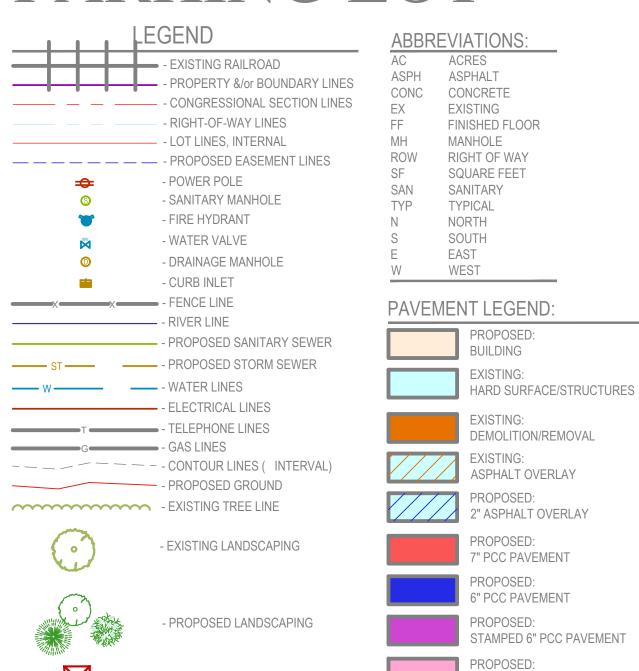
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FLOOR PLAN

STORM SHELTER

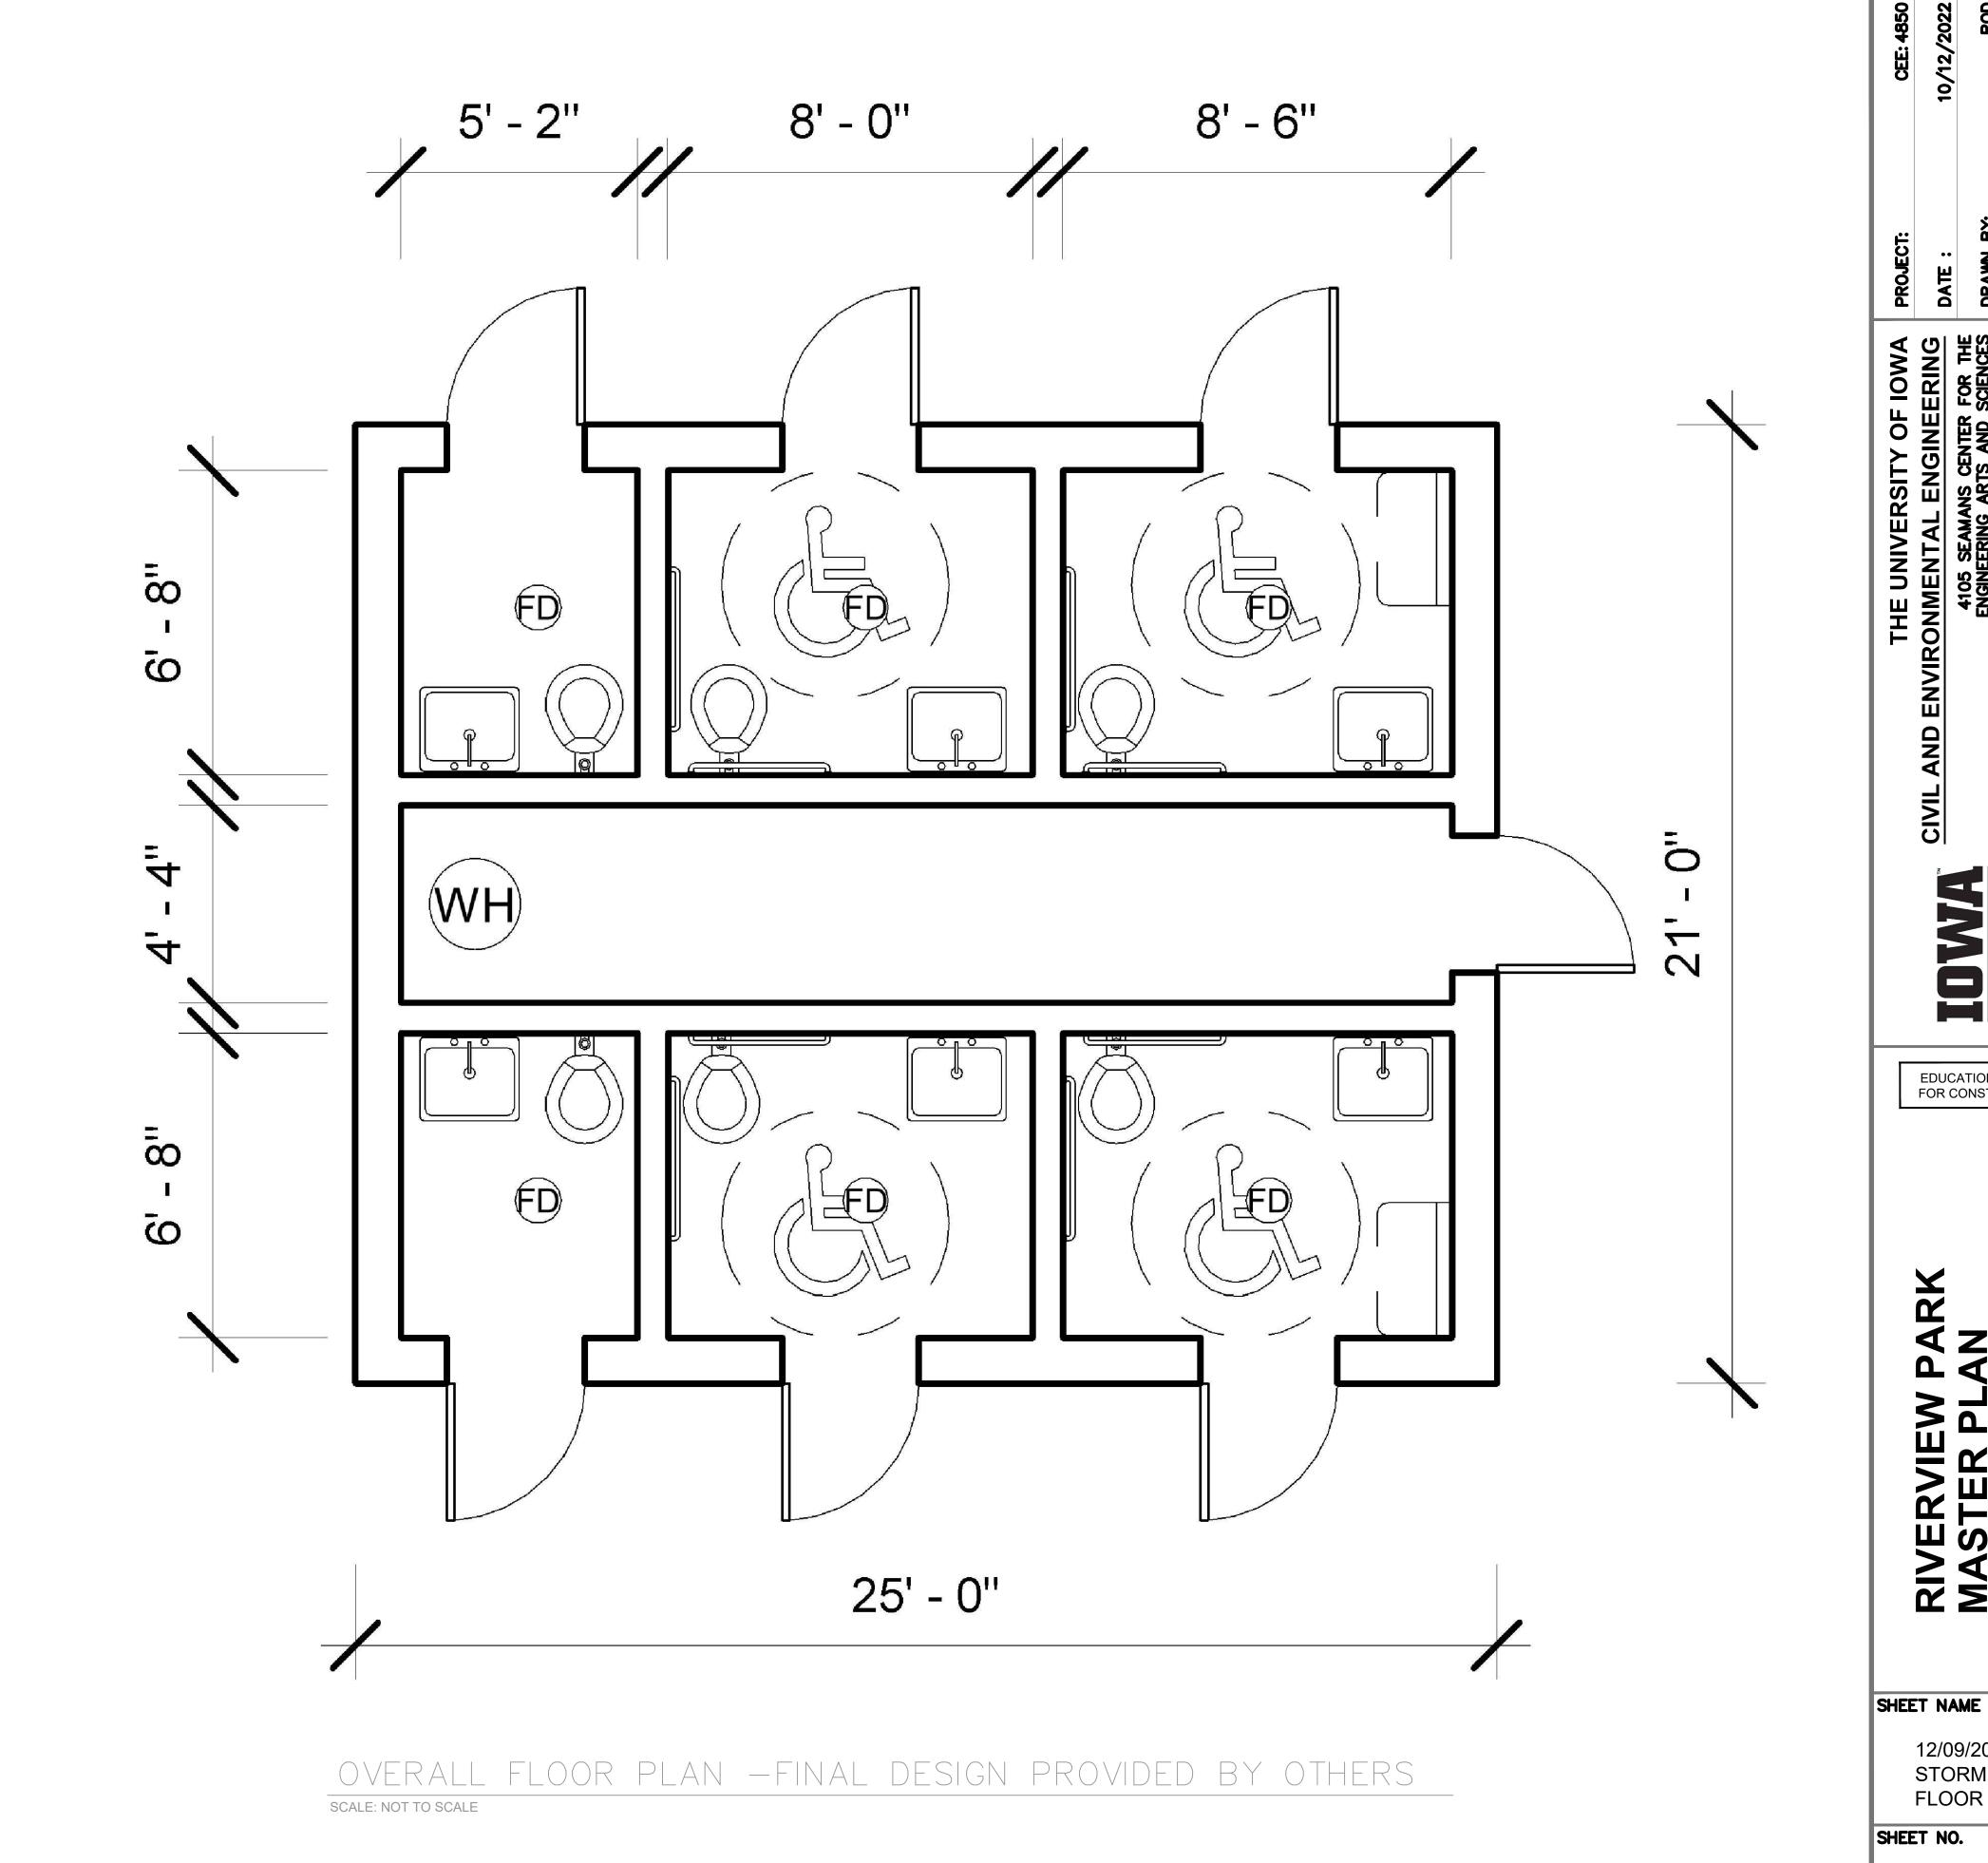

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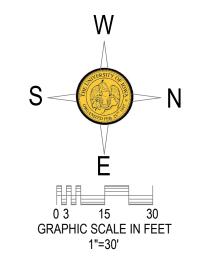
4" PCC PAVEMENT


- POTENTIAL ART LOCATIONS





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RIVERVIEW MASTER PL


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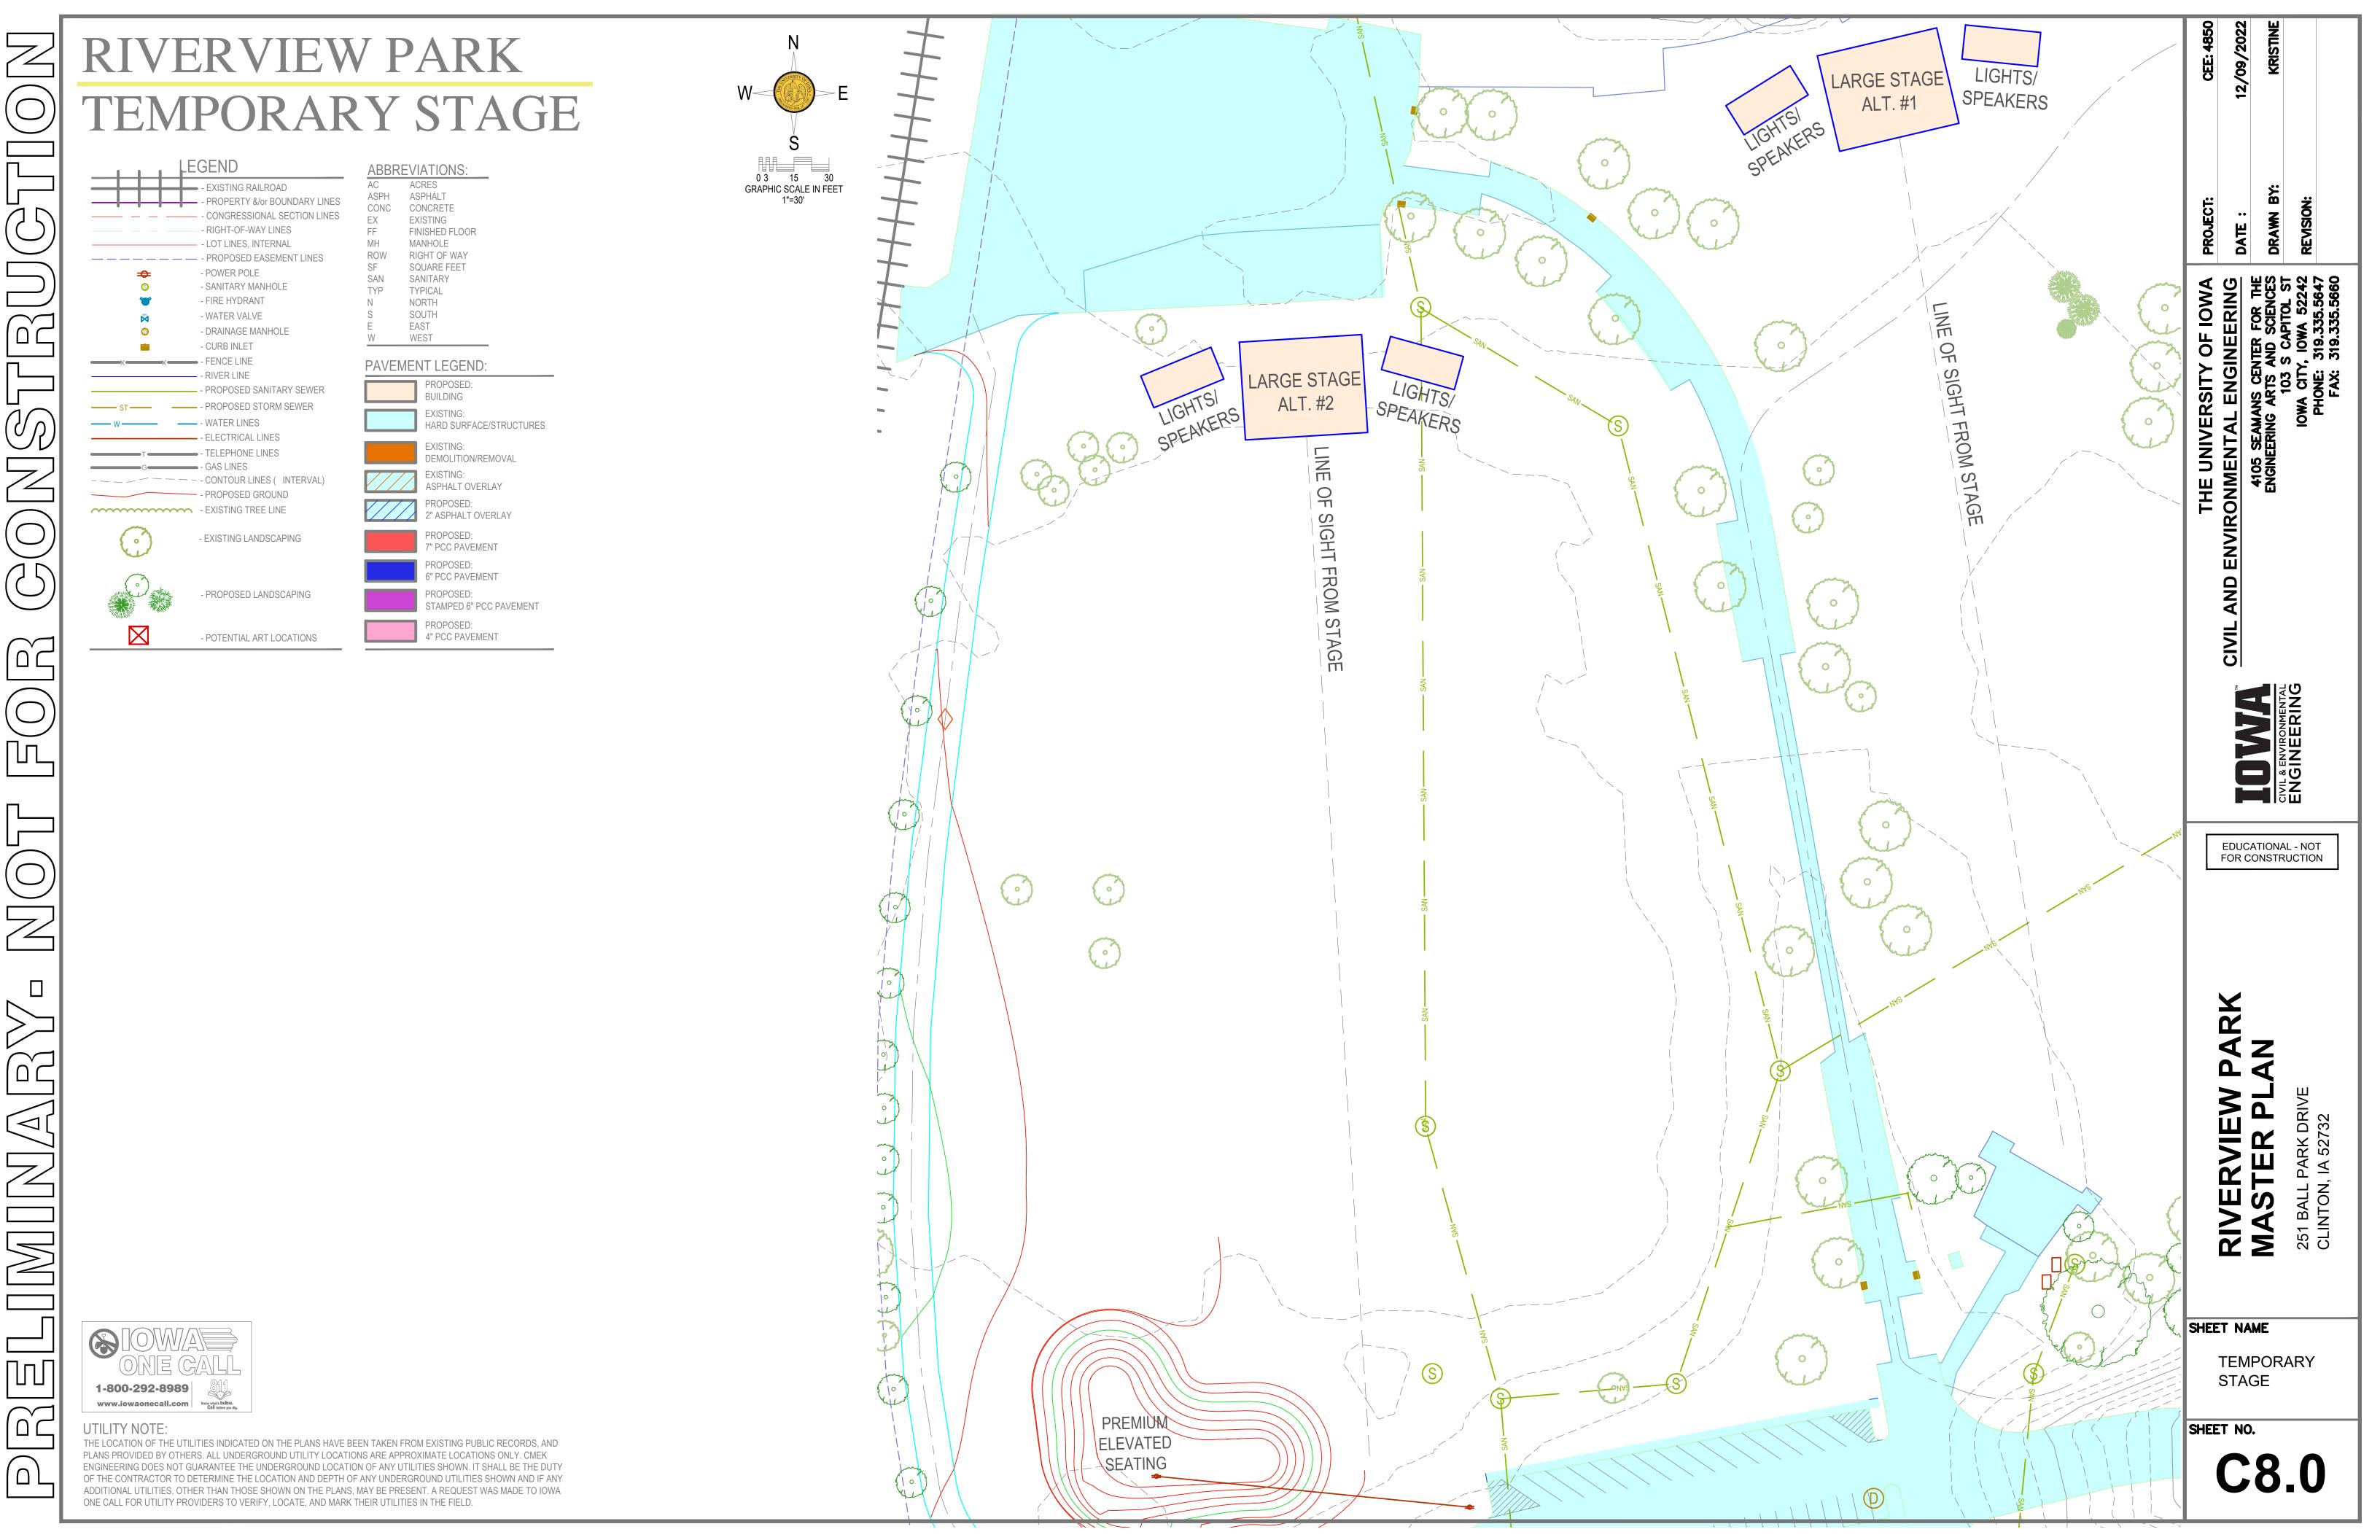
SHEET NO.

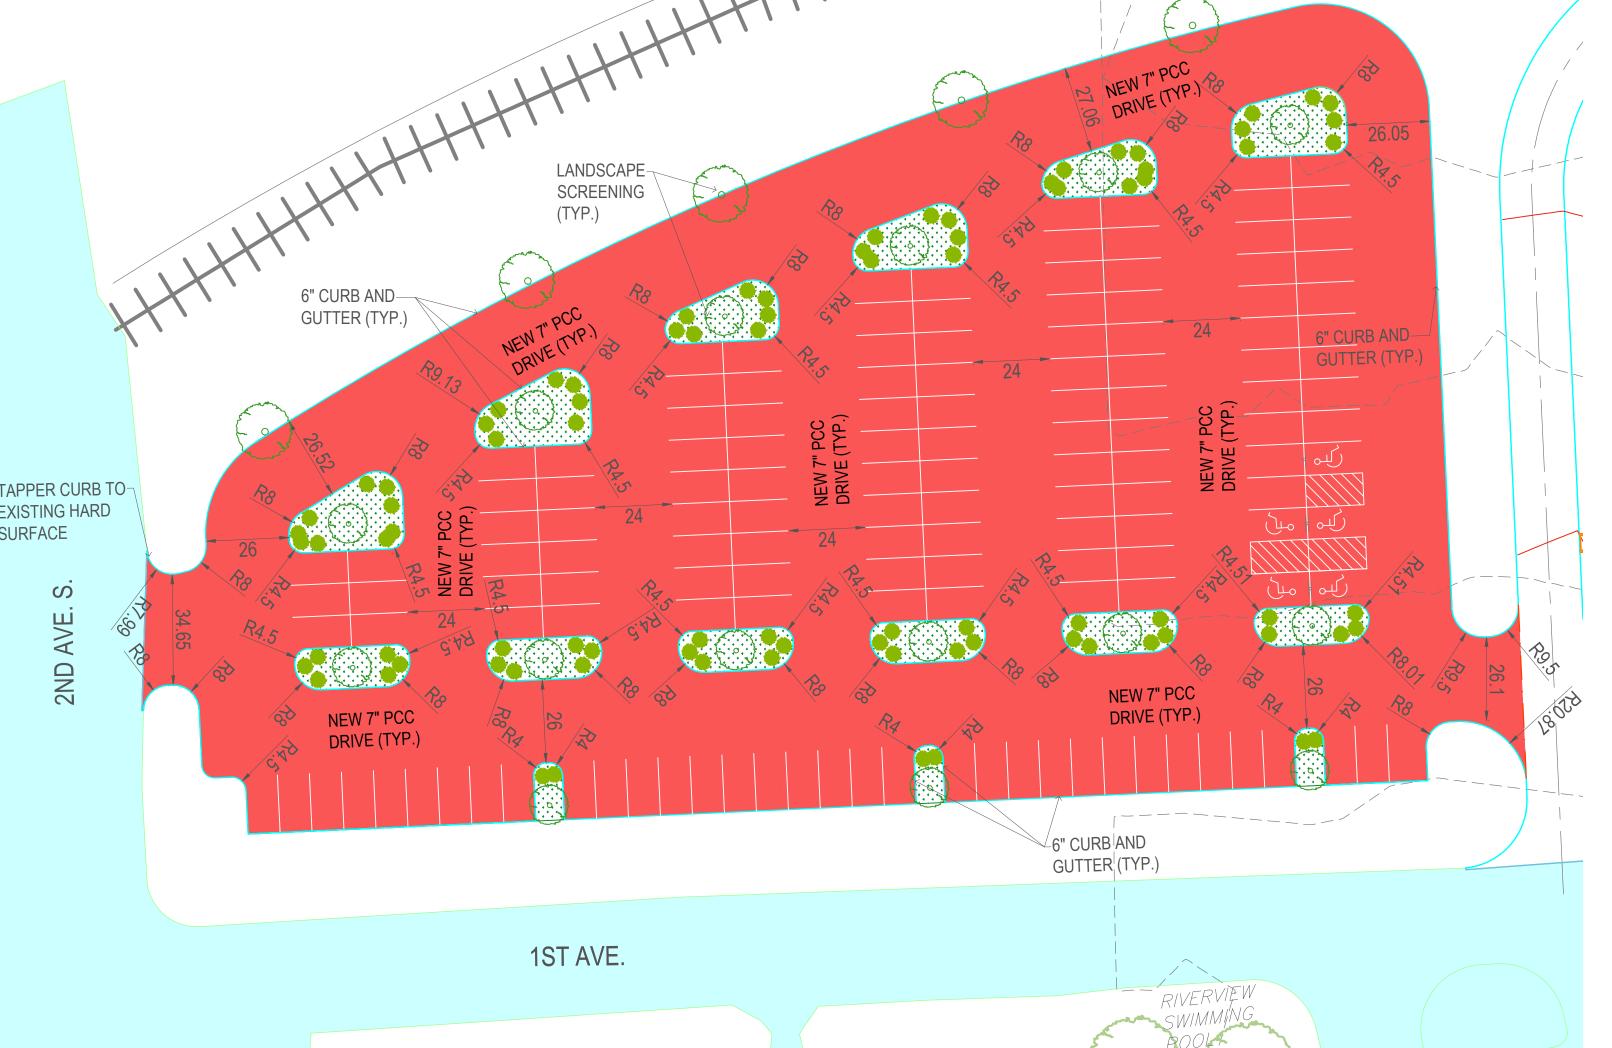PARKING LOT

LAYOUT

251 BALL PARK DRIVE CLINTON, IA 52732



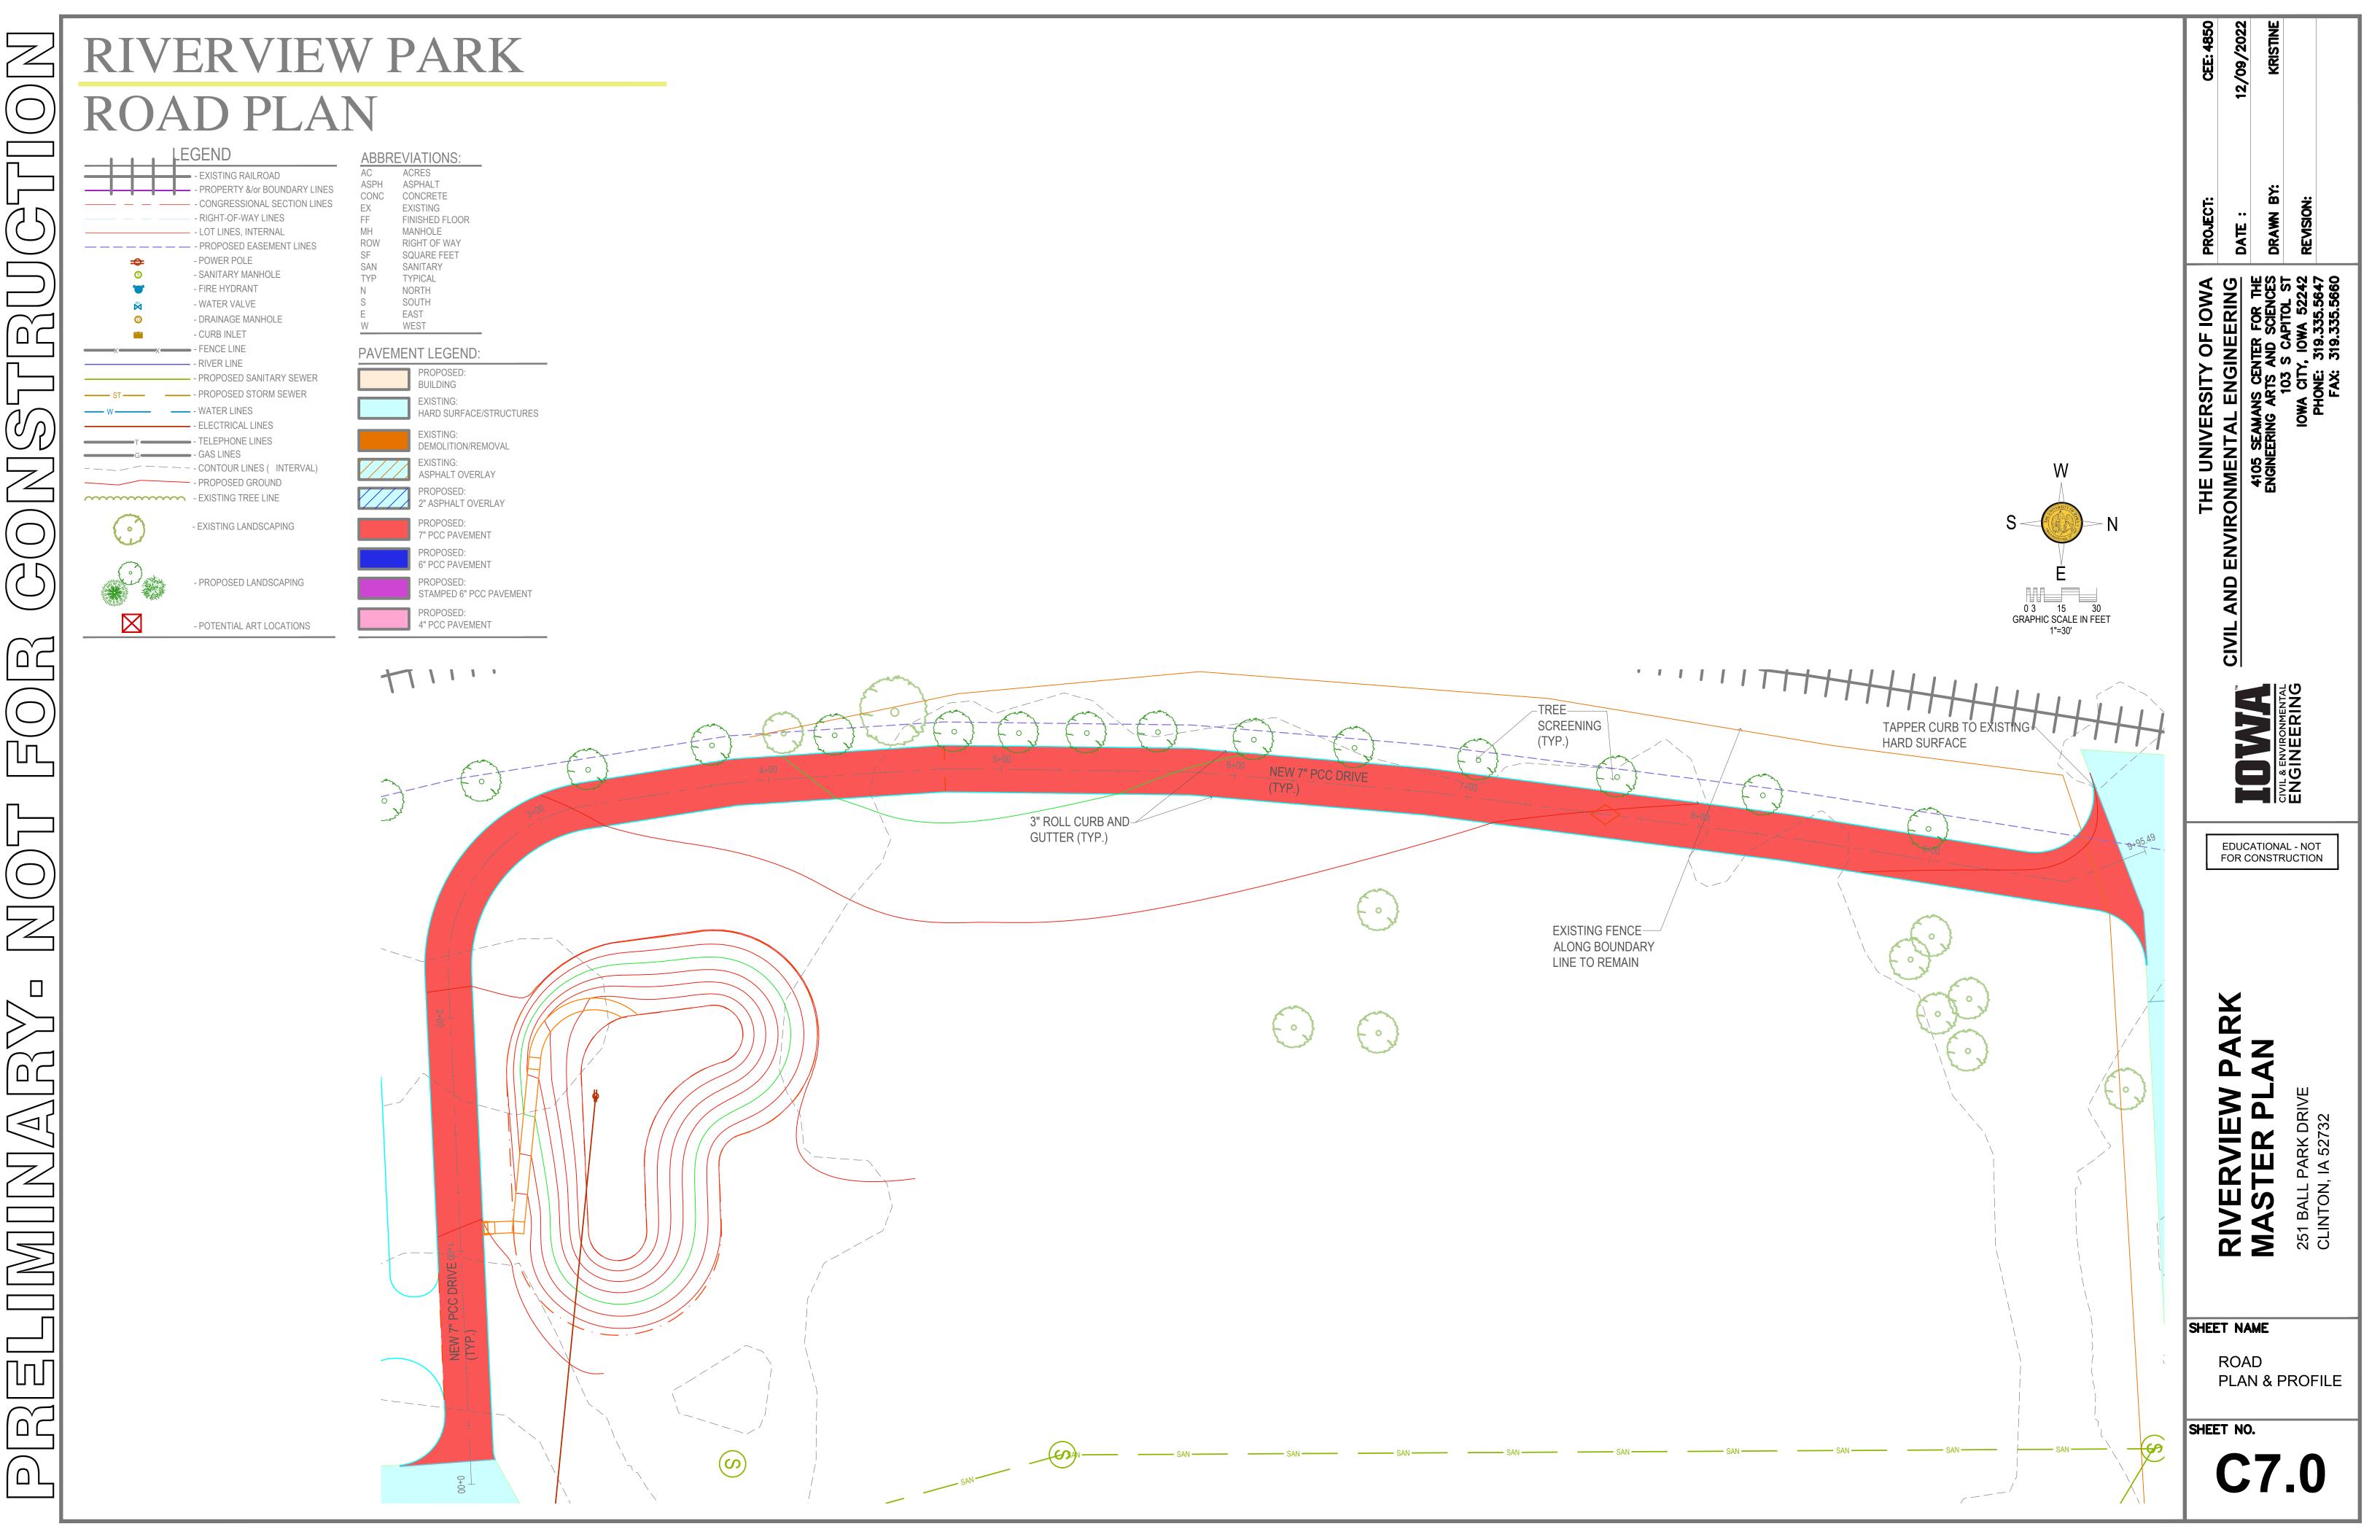



## RIVERVIEW PARK DETAILS


\*ALL DETAILS ARE CONCEPTUAL AND FOR REFERENCE ONLY

#### **PAVING NOTES:**

- 1. SUB-GRADE PREPARATION AND PAVEMENTS NEED TO BE CONSTRUCTED FOLLOWING RECOMMENDATIONS IN THE SOILS REPORT. APPROVED SOILS ENGINEER MUST SIGN OFF ON SUB BASE PRIOR TO ANY PAVEMENT BEING PLACED.
- 2. ALL PEDESTRIAN WALKWAYS THAT UNLOAD INTO A VEHICLES TRAVELED PATH MUST HAVE A.D.A. DETECTABLE WARNING PANEL(S) AS PER A.D.A. REGULATIONS. PANEL TYPE & COLOR SHALL BE PER CITY STANDARD.
- 3. ALL WALKS, PARKING LOTS, HANDICAP PARKING, RAMPS, ETC. SHALL COMPLY WITH ALL A.D.A. AND CITY CODES. HANDICAP PARKING SIGNAGE IS REQUIRED FOR ALL HANDICAP STALLS AND SHALL BE CONSIDERED INCIDENTAL. IN EVENT OF A DISCREPANCY BETWEEN THE PLANS AND THE A.D.A./CITY CODES THE A.D.A./CITY CODES SHALL GOVERN. RESPONSIBILITY FOR ENSURING A.D.A. CODES ARE MET.

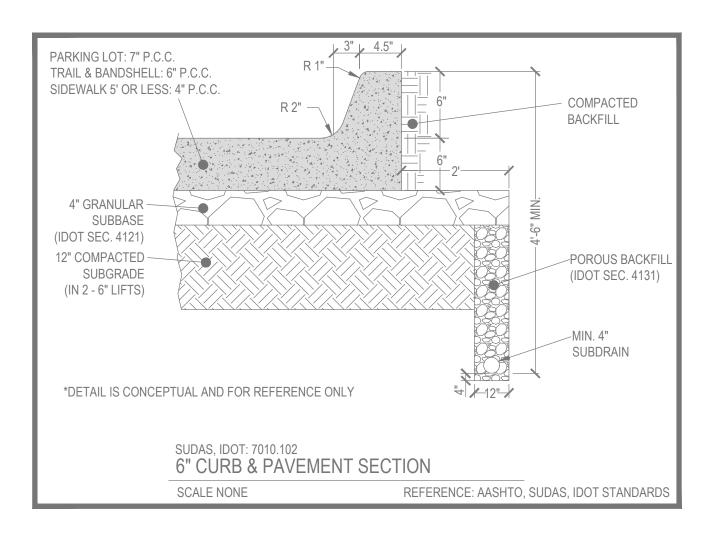

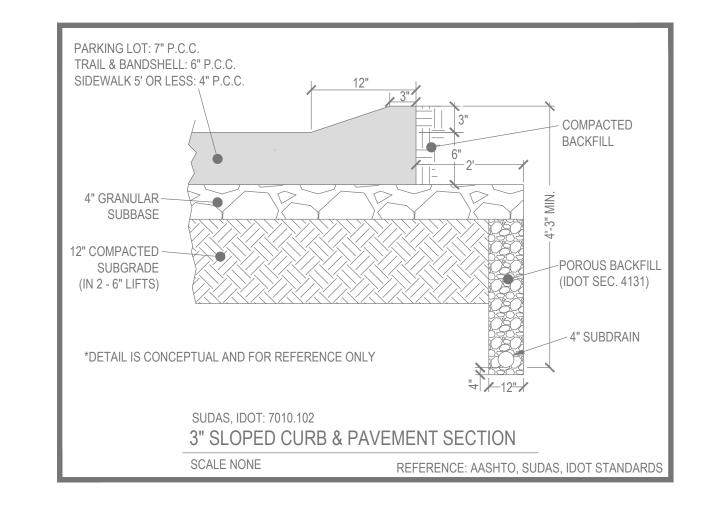

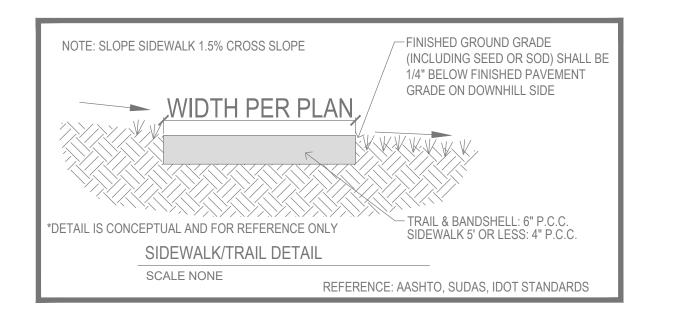

CEE: 4850 12/09/2023

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PROJECT: DATE:

EAMANS CENTER FOR TRING ARTS AND SCIENC 103 S CAPITOL IOWA CITY, IOWA 522

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SHEET NAME

DETAILS

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